




SHEET INDEX

SHEET NUMBER	SHEET TITLE
C1.0	COVER SHEET
C1.1	EXISTING CONDITIONS, DEMOLITION & TESC PLAN
C1.2	TESC PLAN NOTES & DETAILS
C2.0	GRADING AND DIMENSIONAL PLAN
C2.1	UTILITY PLAN
C2.2	CENTER STREET ROADWAY IMPROVEMENTS - PLAN & PROFILE
C2.3	FOURTH STREET ROADWAY IMPROVEMENTS - PLAN & PROFILE
C3.0	SITE & SEWER DETAILS
C3.1	SEWER & WATER DETAILS
C3.2	WATER, WSDOT STANDARD PLANS & CONSTRUCTION DETAILS
C3.3	WSDOT STANDARD PLANS & SEDIMENT TRAP DETAIL
C4.0	STANDARD SPECIFICATIONS & STORMFILTER DETAIL

LEGEND

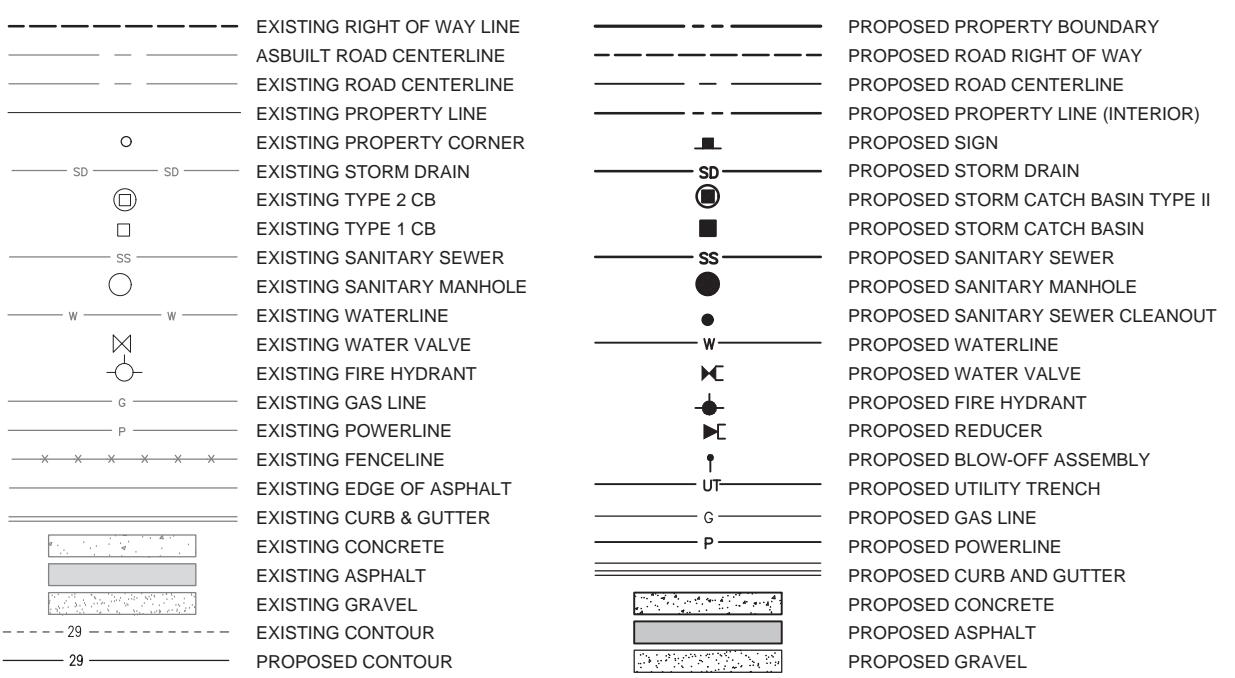

LEGAL DESCRIPTION

THE EAST 3 FEET OF LOT 2 AND ALL OF LOTS 3, 6 AND 7, BLOCK 9, "CALHOUN ADDITION TO THE TOWN OF LA CONNER," AS PER PLAT RECORDED IN VOLUME 1 OF PLATS, PAGE 14, RECORDS OF SKAGIT COUNTY, WASHINGTON.

SITUATE IN THE COUNTY OF SKAGIT, STATE OF WASHINGTON.

NOTE: LEGAL DESCRIPTION FROM EXHIBIT "A" OF STATUTORY WARRANTY DEED RECORDED 08/26/2021 UNDER SKAGIT COUNTY AUDITOR'S FILE NUMBER 202108260088.

SITE INFORMATION

SITE PARCEL NUMBER: P74143
SITE ADDRESS: 306 CENTER STREET; LA CONNER, WA 98257
BUILDING UNITS: 5 AIRBNB LODGING UNITS, 14 APARTMENT DWELLING UNITS

UNDERGROUND UTILITY NOTE

UNDERGROUND UTILITY LOCATIONS SHOWN HEREON ARE BASED ON SURFACE INDICATORS, UTILITY MAPS PROVIDED BY THE CLIENT, SKAGIT COUNTY, AND APS UTILITY SERVICE WAS ALSO USED FOR THEIR LOCATION.

SURVEY/DATUM INFORMATION

BASIS OF BEARING
N 88° 25' 54" W BETWEEN THE FOUND NAILS IN THE INTERSECTIONS OF 3RD AND 4TH ST WITH CENTER ST.

FIELD EQUIPMENT
THIS SURVEY WAS ACCOMPLISHED BY FIELD TRAVERSE WITH A "TRIMBLE S5" AND A TRIMBLE R10-2 GPS RECEIVER, STANDARD ERROR DISTANCE +/- 2CM (+1 PPM), AND MEETS OR EXCEEDS STANDARDS AS SET FORTH IN W.A.C. CH. 332-130.

HORIZONTAL DATUM
WASHINGTON STATE PLANE NORTH ZONE 4601 (NAD 83/2012) USING W.S.R.N.

VERTICAL DATUM
THE VERTICAL DATUM FOR THIS PROJECT IS NAVD 88 BASED ON W.S.R.N. GPS TIE. THE ELEVATION OF THE SOUTHWEST TOP HOLD DOWN BOLT ON THE FIRE HYDRANT AT THE INTERSECTION OF 4TH ST. AND CENTER ST. HAS AN ELEVATION OF 9.47' NAVD AS SHOWN HEREON.

BASE FLOOD ELEVATION = 8.0' NGVD 29 + 3.8' = 11.8' NAVD 88

UNDERGROUND UTILITY LOCATIONS
UNDERGROUND UTILITY LOCATIONS SHOWN HEREON ARE BASED ON SURFACE INDICATORS.

RESEARCH
1) R.O.S. AFN 8407190146
2) R.O.S. AFN 200904240003
PLAT OF CALHOUN ADDITION TO THE TOWN OF LA CONNER VOL. 1, PAGE 14


OWNER:
KSA INVESTMENTS, LLC
BRANDON ATKINSON
16530 MOONLIGHT CLUB DRIVE
BURLINGTON, WA 98233
EM: brandon.kate.atkinson@gmail.com

CONTRACTOR:
FABER CONSTRUCTION
DALE KING
6851 HANNEGAN ROAD
LYNNWOOD, WA 98264
PH: 360.354.3500
EM: dale@faberconstruction.com

ENGINEER/SURVEYOR:
SOUND DEVELOPMENT GROUP, LLC
PAT SEVERIN / JAY STANDISH
1111 CLAYTON AVENUE, SUITE 202
MOULDS VERNON, WA 98273
PH: 360.404.2010
EM: pat@sdg-llc.com / jay@sdg-llc.com

ARCHITECT:
CHARLES MORGAN & ASSOCIATES, LLC
CHARLIE MORGAN / MISTY KLINK
7001 BELLWOOD AVE.
EVERETT, WA 98203
PH: 425.353.2888
EM: charlie@cmarch.com / misty@cmarch.com

LANDSCAPE ARCHITECT:
ECCODESIGN, LLC
PATRICK DIAZ, PLA
6000 SOUTH FIRST STREET, SUITE B
MOULDS VERNON, WA 98273
PH: 360.419.7400
EM: eccodesign@gmail.com

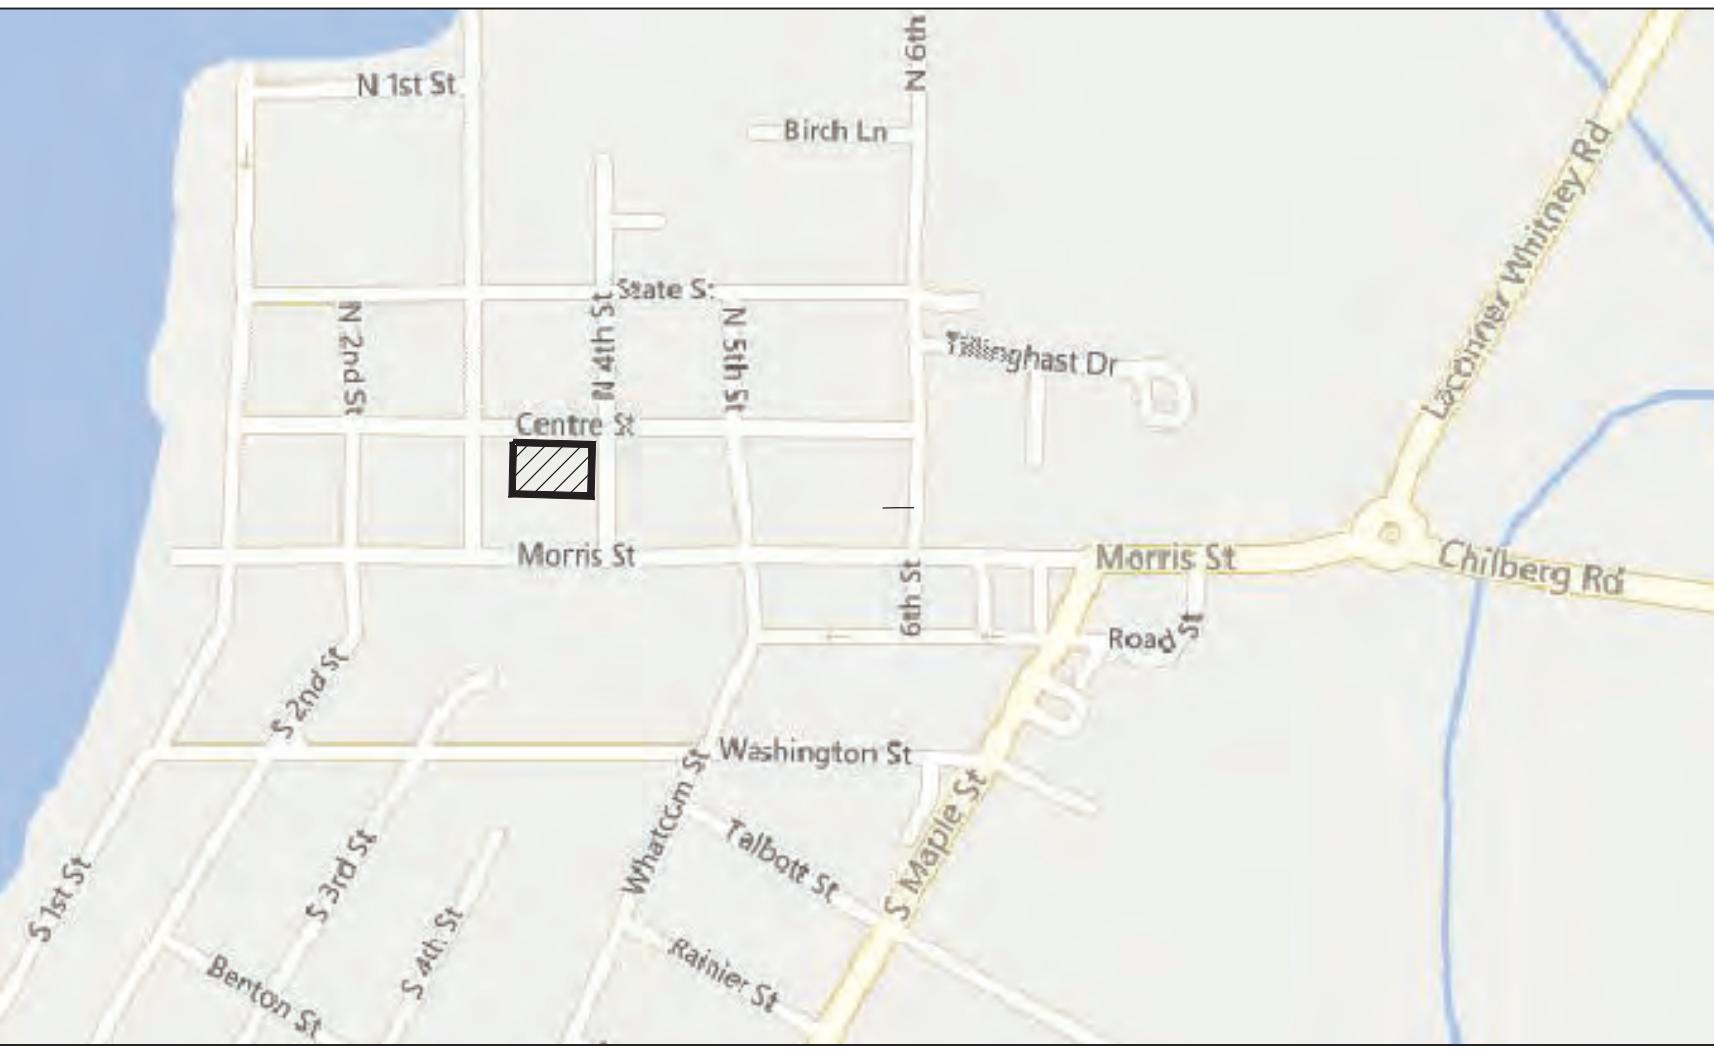

VICINITY MAP
NOT TO SCALE

TOWN OF LA CONNER GENERAL NOTES

- ALL CONSTRUCTION SHALL CONFORM TO THE REQUIREMENTS OF THE TOWN OF LA CONNER THAT ARE CONTAINED IN A BOUND VOLUME ENTITLED "INFRASTRUCTURE IMPROVEMENTS PROJECT MANUAL."
- THE LOCATION OF THE EXISTING UTILITIES SHOWN ON THE DRAWING IS APPROXIMATE. LOCATION AND PROTECTION OF UNDERGROUND UTILITIES SHALL BE IN ACCORDANCE WITH CHAPTER 19.122 RCW. CALL 800-424-5555 AT LEAST TWO BUSINESS DAYS BEFORE ANY EXCAVATION.
- REPLACE ANY DAMAGED OR DESTROYED MONUMENTS.
- THIS PLAN AND PROFILE INFORMATION HAS BEEN FURNISHED BY THE DEVELOPER OR HIS ENGINEER.
- MINIMUM SEPARATION BETWEEN SANITARY SEWERS AND POTABLE WATER LINES SHALL BE 10 FEET HORIZONTALLY (MEASURED SIDE TO SIDE) AND 18 INCHES VERTICALLY FROM BOTTOM OF WATERLINE TO CROWN OF SEWER. MINIMUM VERTICAL SEPARATION FOR PERPENDICULAR OR OBLIQUE CROSSINGS SHALL BE 3 FEET FROM OUTSIDE EDGES. SITUATIONS THAT REQUIRE LESS THAN MINIMUM SEPARATION SHALL BE CONSTRUCTED IN ACCORDANCE WITH DOE'S "CRITERIA FOR SEWAGE WORKS DESIGN", LATEST EDITION.
- THE DEVELOPER SHALL BE RESPONSIBLE FOR ACQUIRING ALL NECESSARY EASEMENTS AND AGREEMENTS PRIOR TO CONSTRUCTION.
- A PLUG SHALL BE PLACED IN THE OUTLET PIPE OF THE EXISTING MANHOLE TO WHICH NEW PIPE IS TO BE CONNECTED OR IN THE OUTLET OF THE FIRST NEW MANHOLE. THIS PLUG SHALL REMAIN IN PLACE AND MAY NOT BE REMOVED WITHOUT THE PERMISSION OF THE TOWN OF LA CONNER. REMOVAL WILL RESULT IN FORFEITURE OF THE SYSTEM ISOLATION DEPOSIT.

CAUTION - EXTREME HAZARD - OVERHEAD ELECTRICAL SERVICE LINES ARE GENERALLY NOT SHOWN ON THE DRAWINGS. ELECTRICAL LINES SHOWN ON THE DRAWINGS ARE LOCATED BY POINT-TO-POINT, POWER-POLE-TO-POWER-POLE CONNECTION. THE CONTRACTOR IS RESPONSIBLE FOR DETERMINING THE EXTENT OF ANY HAZARD CREATED BY OVERHEAD ELECTRICAL POWER IN ALL AREAS AND SHALL FOLLOW PROCEDURES DURING CONSTRUCTION AS REQUIRED BY LAW AND REGULATION. PRIOR TO CONSTRUCTION, THE CONTRACTOR SHALL MEET WITH UTILITY OWNERS AND DETERMINE THE EXTENT OF HAZARD AND REMEDIAL MEASURES, AND SHALL TAKE WHATEVER PRECAUTIONS MAY BE REQUIRED.

UNDERGROUND FIRE LINE REQUIREMENTS

- THE ENTIRE UNDERGROUND FIRE LINE WILL REQUIRE A FULL HYDRO-TEST AT 200 PSI FOR TWO (2) HOURS. CONTACT THE FIRE MARSHAL BEFORE PERFORMING THIS TEST.
- EACH FIRE HYDRANT AND FDC RISER ON THE FIRE SYSTEM WILL REQUIRE A ONE (1) MINUTE FLUSH FROM THE PUMPER PORT OR MANIFOLD WITH A DIFFUSER OR UNTIL THERE ARE NO PARTICULATES IN THE SYSTEM.
- THE PUMPER PORT ON THE HYDRANTS SHALL HAVE A FIVE (5) INCH STORTZ HARD FACED COUPLER INSTALLED PRIOR TO FINAL APPROVAL.
- A COPY OF NFPA U FORM FILLED OUT MUST BE PROVIDED TO THE FIRE MARSHAL PRIOR TO FINAL.
- ALL FITTINGS AND PIPING FROM THE VAULT TO THE BUILDING WILL NEED TO BE INSPECTED BY THE FIRE MARSHAL PRIOR TO COVER.
- THREE (3) SETS OF PLANS, MATERIAL CUT SHEETS AND FIRE FLOW CALCULATIONS WILL NEED TO BE APPROVED PRIOR TO ANY WORK BEING DONE.
- ALL WORK BEING DONE FROM THE DOUBLE CHECK VALVE ASSEMBLY TO THE RISER WILL NEED TO BE INSTALLED BY A U LICENSED CONTRACTOR.
- THE FIRE LINE MUST BE BACKFILLED WITH EITHER SAND OR PEA GRAVEL. NATIVE MATERIALS CANNOT BE USED AS BACKFILL MATERIALS.

PROJECT:

CENTER STREET
MIXED-USE
FOR
KSA INVESTMENTS, LLC

SHEET DESCRIPTION:


COVER SHEET
COVER SHEET



SCALE: NO SCALE
DRAWN BY: C. SEVERIN
DESIGNED BY: P. SEVERIN
DATE: 08.30.2023
JOB NUMBER: 21098
DWG NAME: 21098PLN.DWG
SHEET NUMBER:

C1.0

IN A PORTION OF THE NE QUARTER OF SECTION 36, TOWNSHIP 34 N, RANGE 02 E, W.M.

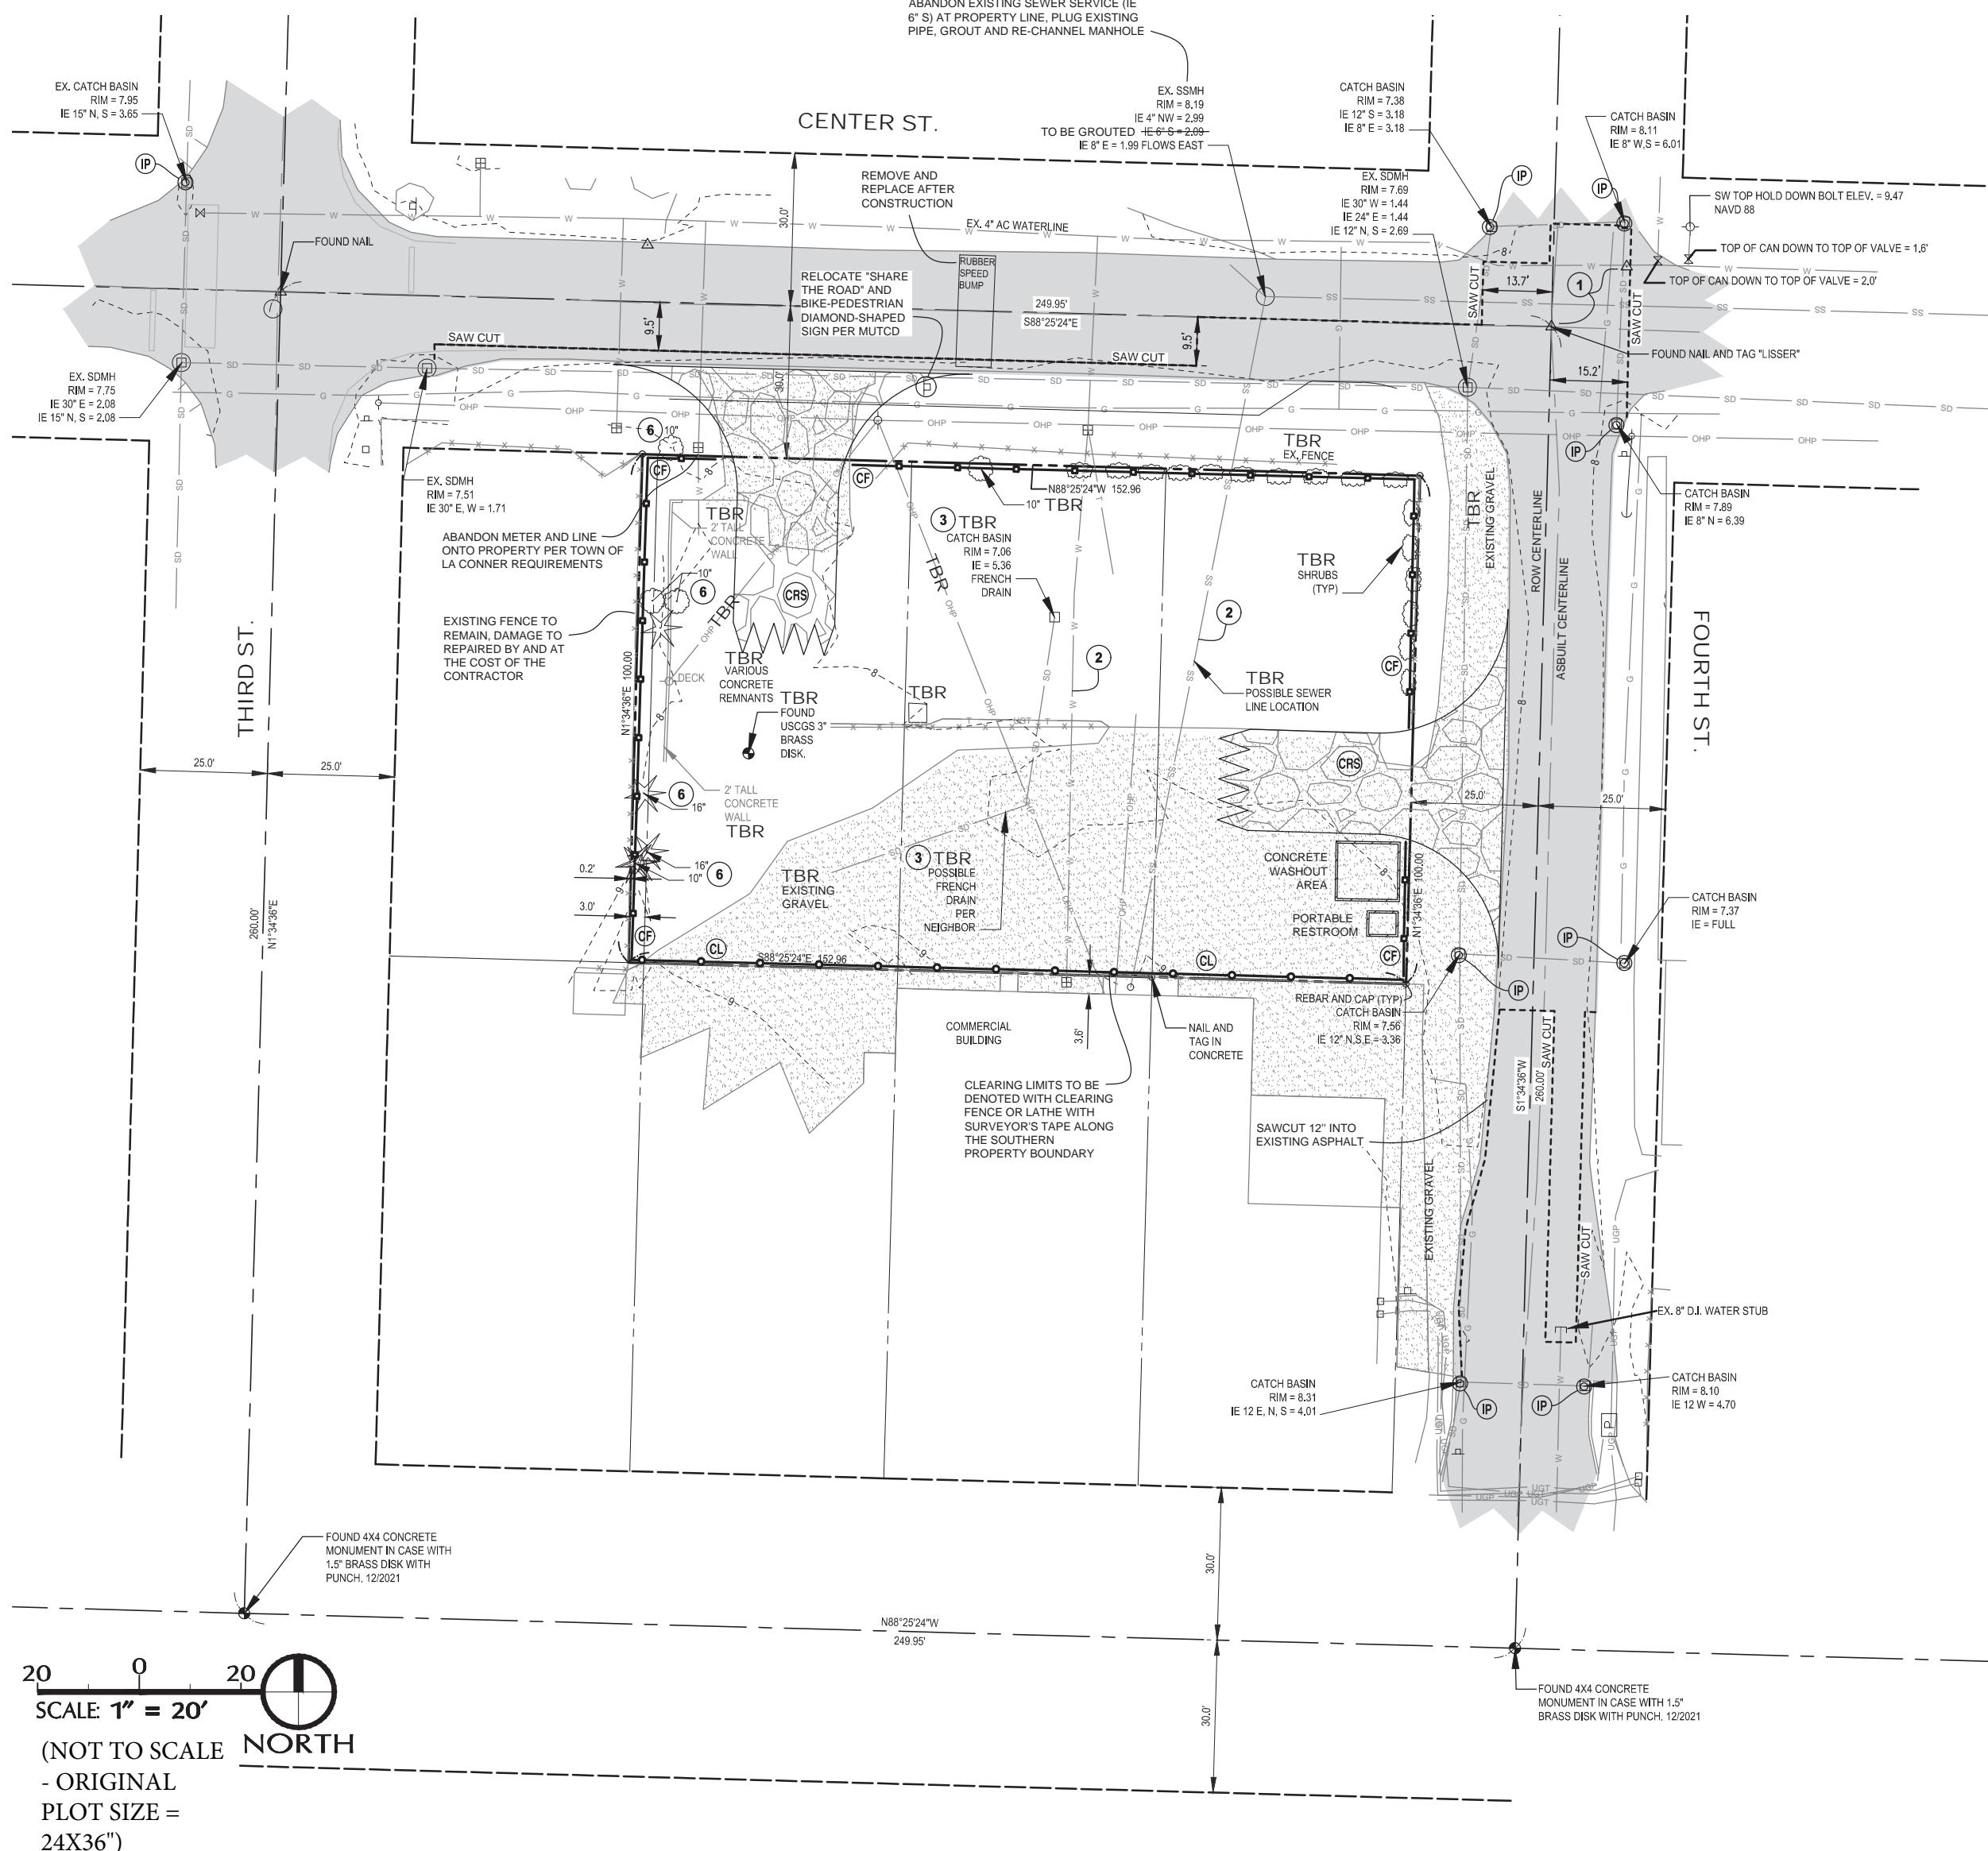

LA CONNER, WASHINGTON

TESC PLAN LEGEND

CODE	SYMBOL	DESCRIPTION
CRS		CONSTRUCTION ROAD STABILIZATION, PER DETAIL A/1.2, IF EXISTING GRAVEL IS NOT SUFFICIENT FOR SEDIMENT REMOVAL FROM WHEELS. INSTALL RUMBLE STRIP PLATES AT ENTRANCE AND EXIT, AS REQUIRED BY THE FILL, GRADE AND/OR CLEARING PERMIT APPROVED ON 8/15/23 BY THE TOWN OF LA CONNER
CF		ORANGE CONSTRUCTION FENCE (BMP C103) OR EQUIVALENT HIGH VISIBILITY FENCE AT CESCL DISCRETION DURING DRY SEASON, SILT FENCE DURING WET SEASON
CL		CLEARING LIMITS - CLEARING / ORANGE CONSTRUCTION FENCE (BMP C103) OR LATHE AND SURVEYOR'S TAPE
VEG		RETAIN EXISTING VEGETATION
IP		INLET PROTECTION PER DETAIL B/1.2, TO BE INSTALLED ON ALL PROPOSED AND EXISTING CBs WITH OPEN GRATES
SP		SILT PROTECTION - STRAW WADDLES
PS		PERMANENT SEEDING AND PLANING, BMP C120 AND BMP T5.13
DC		DUST CONTROL
TBR		TO BE REMOVED

TESC NOTES:

1. SILT FENCE SHALL BE INSTALLED IF WARRANTED BY SITE CONDITIONS AS DETERMINED BY THE PROJECT CESCL, ENGINEER OR CITY OF LA CONNER. THE FENCE SHALL BE PLACED AS REQUIRED TO PREVENT SILT LADEN RUNOFF FROM LEAVING THE SITE. SEE DETAIL A/2.2 FOR SILT FENCE INSTALLATION.
2. TRENCH SPOILS ARE TO BE PLACED ON THE UPHILL SIDE OF THE TRENCH WHERE FEASIBLE.
3. WHEN FEASIBLE, NO MORE THAN 500 LF OF TRENCH SHALL BE OPENED AT ONE TIME. TRENCH SPOILS ARE TO BE PLACED ON THE UPHILL SIDE OF THE TRENCH AND DEWATERING, ALTHOUGH NOT EXPECTED, WILL BE DISCHARGED TO THE SEDIMENT TRAP. SEDIMENT TRAP, IF NOT EXISTING, IS THE RESPONSIBILITY OF THE CONTRACTOR. SEE DETAIL A/2.2 FOR SEDIMENT TRAP AND SITES OF 500 LF.
4. CONSTRUCTION ACCESS WILL BE PROVIDED THROUGH THE TWO EXISTING GRAVELED ACCESS POINTS, ONE AS AN ENTRANCE AND THE OTHER AS AN EXIT. SHOULD THE EXISTING GRAVEL AREAS NOT RETAIN SEDIMENTS FROM VEHICLE WHEELS, A CONSTRUCTION ACCESS IS TO BE INSTALLED PER DETAIL A/1.2. REFER TO THE TESC PLAN NOTES ON SHEET C1.2 FOR INFORMATION ON STREET SWEEPING AND WASHING.
5. ALL TRUCKS ARE TO BE REMOVED WITHIN 30 DAYS AFTER FINAL SITE STABILIZATION.
6. NO CONCRETE TRUCKS WILL BE ALLOWED TO WASHOUT ON-SITE. THE CONCRETE WASHOUT AREA HAS BEEN DENOTED FOR CONCRETE POURING AND FINISHING TOOLS ONLY.
7. NO VEHICLE MAINTENANCE IS ALLOWED ON-SITE.
8. ALL FENCE LINES ARE TO BE RERECTED AND MAINTAINED ON A REGULAR BASIS, AS DETERMINED BY THE TIME OF YEAR AND RAINFALL EVENTS. INLET PROTECTION IS TO BE INSTALLED ON ALL STORM STRUCTURES WITH OPEN GRATES WITHIN 300' OF THE SITE, WHICH MAY NOT BE SHOWN ON THE PLANS.

EXISTING CONDITIONS NOTES

1. CONTRACTOR TO MINIMIZE IMPACT TO ALL FOUND MONUMENTS AND TO SCHEDULE RESTORATION OF MONUMENT BY A LICENSED PROFESSIONAL LAND SURVEYOR AT THE COMPLETION OF CONSTRUCTION, AS NECESSARY AND APPROPRIATE. EXISTING USCGS 3' BRASS DISK IS TO BE REMOVED AND WILL NOT BE REPLACED, AS PRE-AUTHORIZED BY USCGS.
2. CONTRACTOR TO POTHOLE AND CAP ALL UTILITY LINES DO NOT SERVE OTHER PROPERTIES. IF NOT, CONTRACTOR TO CALL FOR DISCONNECTION, CAPPING, AND REMOVAL OF THE UTILITY LINES UTILIZING THE SITE FROM THE NORTH AND SOUTH PROPERTY LINES UNDER-GROUND AND ABOVE-GROUND UTILITIES ARE TO BE DISCONNECTED AT THE DIRECTION OF THE ASSOCIATED UTILITY PURVEYOR. ALL NECESSARY WORK (TRENCHING, BACKFILL, COMPACTION, ETC) IS THE RESPONSIBILITY OF THE CONTRACTOR, UNLESS UTILITY PURVEYOR SPECIFIES OTHERWISE.
3. WATER AND SANITARY SEWER LINES ARE TO REMAIN LIVE UNTIL UTILITY IMPROVEMENTS ARE MADE ON FOURTH STREET, PER UTILITY PLAN, AND SERVICE IS RESTORED TO THE EXISTING LINES AND METER.
4. CONTRACTOR TO POTHOLE STORM LINE AND CONFIRM IF THE STORM LINE/TRENCH DRAIN IS LIMITED TO THE SUBJECT PROPERTY. SHOULD THE FEATURE BE LIMITED TO THIS PROPERTY, THE STORM LINE AND TRENCH DRAIN IS TO BE REMOVED. SHOULD THE FEATURE NOT BE LIMITED TO THE SUBJECT PROPERTY, THE ENGINEER IS TO BE CONTACTED IMMEDIATELY FOR RE-ROUTING PLANS.
5. CONTRACTOR TO LOCATE ALL NEXT INLINE VALVES PRIOR TO CONSTRUCTION AND/OR WORK ON WATER SYSTEM.
6. CONTRACTOR TO COORDINATE ALL UTILITY AND ROAD SHUT-DOWN PERIODS WITH THE TOWN OF LA CONNER, EMERGENCY DEPARTMENTS, UTILITY PURVEYORS AND AFFECTED PROPERTIES (COMMERCIAL AND RESIDENTIAL). CONTRACTOR TO PROVIDE TRAFFIC CONTROL PLAN, APPROVED BY THE TOWN OF LA CONNER, PRIOR TO BEGINNING CONSTRUCTION.
7. LANDSCAPING AND EXISTING SHRUBS ALONG THE WESTERN PROPERTY BOUNDARY ARE TO BE REMOVED. CONTRACTOR TO COORDINATE WITH NEIGHBORS SHOULD EXISTING FEATURES, THAT ARE TO REMAIN (I.E. FENCE LINES), ARE AFFECTED DURING THE REMOVAL PROCESS.

PROJECT:


CENTER STREET
MIXED-USE
FOR
KSA INVESTMENTS, LLC

SHEET DESCRIPTION:
EXISTING CONDITIONS,
DEMOLITION
AND TESC PLAN



SCALE: 1" = 20'
DRAWN BY: C. SEVERIN
DESIGNED BY: P. SEVERIN
DATE: 08.30.2023
JOB NUMBER: 21098PLN.DWG
DWG NAME: 21098PLN.DWG
SHEET NUMBER:

C1.1

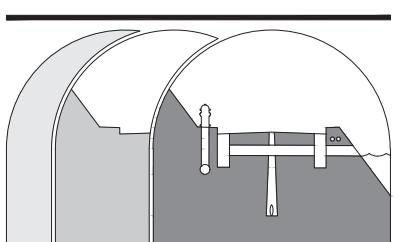

Sound Development Group
ENGINEERING, SURVEYING & LAND DEVELOPMENT SERVICES
P.O. Box 1705 • 1111 Cleveland Avenue, Suite 202
Mount Vernon, WA 98273 Tel: 360-404-2010

SHEET REVISIONS:
NO. DATE DESCRIPTION APPROVED P.L.S.
1 9.22.23 ARCHITECT REVISION

**CALL 48 HOURS
BEFORE YOU DIG**
1.800.424.5555

IN A PORTION OF THE NE QUARTER OF SECTION 36, TOWNSHIP 34 N, RANGE 02 E, W.M. LA CONNER, WASHINGTON

ESC-1 STANDARD ESC NOTES

APPROVAL OF THIS EROSION AND SEDIMENT CONTROL (ESC) PLAN DOES NOT CONSTITUTE AN APPROVAL OF PERMANENT ROAD OR DRAINAGE DESIGN (E.G., SIZE AND LOCATION OF ROADS, PIPES, RESTRICTORS, CHANNELS, RETENTION FACILITIES, UTILITIES, ETC.).

1. AS DIRECTED BY PUBLIC WORKS DIRECTOR PRIOR TO COMMENCING CONSTRUCTION, ALL CRITICAL AREAS, INCLUDING WETLAND BUFFERS, STREAM CORRIDOR, LANDFILL AREAS, AND STEEP SLOPES SHALL BE CONTINUOUSLY DEMARCATED IN THE FIELD USING FLAGGING TAPE OR FENCING.
2. EROSION CONTROL METHODS AND MATERIALS SHALL MEET REQUIREMENTS OF SECTION 8-01 OF THE APHA/WASHINGTON STATE DEPARTMENT OF TRANSPORTATION 2022 STANDARD SPECIFICATIONS FOR ROAD, BRIDGE, AND MUNICIPAL CONSTRUCTION, AND REQUIREMENTS SET FORTH IN VOLUME II OF THE "STORMWATER MANAGEMENT MANUAL FOR THE PUGET SOUND BASIN (THE TECHNICAL MANUAL)", BY THE WASHINGTON STATE DEPARTMENT OF ECOLOGY, CURRENT EDITION. THE CONTRACTOR SHALL FOLLOW RECOMMENDATIONS MADE BY SUPPLIERS AND MANUFACTURERS OF MATERIALS AND EQUIPMENT USED.
3. THE ESC FACILITIES SHOWN ON THIS PLAN MUST BE CONSTRUCTED IN CONJUNCTION WITH ALL CLEARING AND GRADING ACTIVITIES IN SUCH A MANNER AS TO ENSURE THAT SEDIMENT-LADEN WATER DOES NOT ENTER THE DRAINAGE SYSTEM OR VIOLATE APPLICABLE WATER STANDARDS, AND MUST BE INSTALLED AND IN OPERATION PRIOR TO ANY GRADING OR LAND CLEARING. WHEREVER POSSIBLE, MAINTAIN NATURAL VEGETATION FOR SILT CONTROL.
4. THE ESC FACILITIES SHOWN ON THIS PLAN ARE THE MINIMUM REQUIREMENTS FOR ANTICIPATED SITE CONDITIONS. DURING THE CONSTRUCTION PERIOD, THESE ESC FACILITIES SHALL BE UPGRADED (E.G., ADDITIONAL SPLASH, RELOCATION OF DITCHES AND SILT FENCES, ETC.) AS NEEDED FOR UNEXPECTED SITES CONDITIONS. THESE ESC FACILITIES ARE REQUIRED TO ENSURE COMPLETE EROSION CONTROL. THEREFORE, DURING THE COURSE OF CONSTRUCTION, IT SHALL BE THE OBLIGATION AND RESPONSIBILITY OF THE CONTRACTOR TO ADDRESS ANY NEW CONDITIONS THAT MAY BE CREATED BY HIS ACTIVITIES AND TO PROVIDED ADDITIONAL FACILITIES OVER AND ABOVE THE MINIMUM REQUIREMENTS AS MAY BE NEEDED.
5. ANY PERMANENT RETENTION/DETENTION FACILITY USED AS A TEMPORARY SETTLING BASIN SHALL BE MODIFIED WITH THE NECESSARY EROSION CONTROL MEASURES AND SHALL PROVIDE ADEQUATE STORAGE CAPACITY. IF THE PERMANENT FACILITY IS TO FUNCTION ULTIMATELY AS AN INFILTRATION OR DISPERSION SYSTEM, THE FACILITY SHALL NOT BE USED AS A TEMPORARY SETTLING BASIN. NO UNDERGROUND DETENTION TANK, DETENTION VAULT, OR SYSTEM, WHILE BACKED OVER OR INTO A POND, SHALL BE USED AS A TEMPORARY SETTLING BASIN.
6. WHERE SEEDING FOR TEMPORARY EROSION CONTROL IS REQUIRED, FAST GERMINATING GRASSES SHALL BE APPLIED AT AN APPROPRIATE RATE (EXAMPLE: ANNUAL OR PERENNIAL RYE APPLIED AT APPROXIMATELY 80 POUNDS PER ACRE).
7. WHERE STRAW MULCH IS REQUIRED FOR TEMPORARY EROSION CONTROL, IT SHALL BE APPLIED AT A MINIMUM THICKNESS OF TWO (2) INCHES.
8. ALL WORK AND MATERIALS SHALL BE IN ACCORDANCE WITH THE TOWN OF LA CONNER STANDARDS AND SPECIFICATIONS.
9. THE ESC FACILITIES SHALL BE CONSTRUCTED IN ACCORDANCE WITH THE DETAILS OF THE APPROVED PLANS. LOCATIONS MAY BE MOVED TO SUIT FIELD CONDITIONS, SUBJECT TO APPROVAL BY THE TOWN OF LA CONNER PUBLIC WORKS DIRECTOR AND TOWN OF LA CONNER INSPECTOR.
10. A COPY OF THE APPROVED EROSION CONTROL PLANS MUST BE ON THE JOB SITE WHENEVER CONSTRUCTION IS IN PROGRESS.
11. ALL LOTS ADJOINING OR HAVING ANY NATIVE GROWTH PROTECTION EASEMENTS (NGPE) SHALL HAVE A FOUR (4) FOOT HIGH TEMPORARY CONSTRUCTION FENCE (CYCLOPS OR PLASTIC) SEPARATING THE LOT (OR BUILDABLE PORTIONS OF THE LOT) FROM THE AREA RESTRICTED BY THE NGPE. THE FENCE SHALL BE REMOVED PRIOR TO ANY GRADING OR CLEARING AND REMAIN IN PLACE UNTIL A DWELLING IS CONSTRUCTED AND OWNERSHIP TRANSFERRED TO THE FIRST OWNER/OCCUPANT.
12. A CLEARING CONTROL FENCE SHALL BE INSTALLED AT THE HIP LINE OF TREES TO BE SAVED. WHEREVER THE TREE CANOPES EXTEND INTO THE AREA TO BE CLEARED, ON-SITE SUPERVISION SHALL BE PROVIDED. WHENEVER EQUIPMENT MUST OPERATE UNDER TREE CANOPES, AND FENCING SHALL BE REPLACED WHEN NECESSARY, THE CLEARING CONTROL FENCE SHALL CONSIST OF A SINGLE STRAND OF WIRE ATTACHED ABOUT THREE (3) FEET HIGH TO WOOD LATH AT A TWELVE (12') FOOT MAXIMUM SPACING AND FLAGGED WITH SURVEY RIBBON AT FOUR (4) FOOT INTERVALS.
13. OFF-SITE STREETS MUST BE KEPT CLEAN AT ALL TIMES. IF DIRT IS DEPOSITED ON THE PUBLIC STREET SYSTEM, THE STREET SHALL BE IMMEDIATELY CLEANED WITH A POWER SWEEPER OR OTHER EQUIPMENT. ALL VEHICLES SHALL LEAVE THE SITE BY WAY OF THE CONSTRUCTION ENTRANCE AND SHALL CLEANED OF ALL DIRT THAT WOULD BE DEPOSITED ON THE PUBLIC STREETS.
14. ANY CATCH BASINS COLLECTING RUNOFF FROM THE SITE, WHETHER THEY ARE ON OR OFF THE SITE, SHALL HAVE THEIR GRATES COVERED WITH FILTER FABRIC DURING CONSTRUCTION.
15. THE WASHED GRAVEL BACKFILL ADJACENT TO THE FILTER FABRIC FENCE SHALL BE REPLACED AND THE FILTER FABRIC CLEANED IF IT IS NONFUNCTIONAL OR EXCESSIVE SILT ACCUMULATION AS DETERMINED BY THE TOWN OF LA CONNER. ALSO, ALL INTERCEPTOR SWALES SHALL BE CLEANED IF SILT ACCUMULATION EXCEEDS ONE-QUARTER DEPTH.
16. ROCK FABRIC PROTECTION OF ROADWAY DITCHES, WHERE REQUIRED, MUST BE OF SOUND QUARRY ROCK, PLACED TO DEPTH OF ONE (1) FOOT AND MUST MEET THE FOLLOWING SPECIFICATIONS: 4"-8" ROCK/40%-70% PASSING, 2"-4" ROCK/30%-40% PASSING, AND 1"-2" ROCK/10%-20% PASSING.
17. IF ANY PART(S) OF THE CLEARING LIMIT, BOUNDARY OR TEMPORARY EROSION/SEDIMENTATION CONTROL PLAN IS/ARE DAMAGED, IT SHALL BE REPAVED IMMEDIATELY.
18. ALL PROPERTIES ADJACENT TO THE PROJECT SITE SHALL BE PROTECTED FROM SEDIMENT DEPOSITION AND RUNOFF. DO NOT FLUSH CONCRETE BY-PRODUCTS OR TRUCKS NEAR OR INTO THE STORM DRAINAGE SYSTEM. IF EXPOSED AGGREGATE IS FLUSHED INTO THE STORM SYSTEM, IT COULD MEAN RECLINING THE ENTIRE DOWNSTREAM STORM SYSTEM, OR POSSIBLY RELAYING THE STORM LINE.
19. THE IMPLEMENTATION OF THESE ESC PLANS AND THE CONSTRUCTION, MAINTENANCE, REPLACEMENT AND UPGRADING OF THESE FACILITIES IS THE RESPONSIBILITY OF THE APPLICANT/ESC SUPERVISOR UNTIL ALL CONSTRUCTION IS APPROVED.
20. THE ESC SUPERVISOR NAME IS: _____
24 HR. CONTACT NUMBER IS: _____
21. THE APPLICANT'S NAME IS: _____
24 HR. CONTACT NUMBER IS: _____
22. THE BOUNDARIES OF THE CLEARING LIMITS SHOWN ON THIS PLAN SHALL BE CLEARLY FLAGGED BY A CONTINUOUS LENGTH OF SURVEY TAPE (OR FENCING, IF REQUIRED) PRIOR TO CONSTRUCTION. DURING THE CONSTRUCTION PERIOD, NO DISTURBANCE BEYOND THE CLEARING LIMITS SHALL BE PERMITTED. THE CLEARING LIMITS SHALL BE MAINTAINED BY THE APPLICANT/ESC SUPERVISOR FOR THE DURATION OF CONSTRUCTION.
23. THE ESC FACILITIES SHALL BE INSPECTED DAILY BY THE APPLICANT/ESC SUPERVISOR AND MAINTAINED TO ENSURE CONTINUED PROPER FUNCTIONING. WRITTEN RECORDS SHALL BE KEPT OF WEEKLY REVIEWS OF THE ESC FACILITIES DURING THE WET SEASON (OCT. 1 TO APRIL 30) AND OF THE MONTHLY REVIEWS DURING THE DRY SEASON (MAY 1 TO SEPT. 30).
24. ANY AREAS OF EXPOSED SOILS, INCLUDING ROADWAY EMBANKMENTS, THAT WILL NOT BE DISTURBED FOR TWO DAYS DURING THE WET SEASON OR SEVEN DAYS DURING THE DRY SEASON SHALL BE IMMEDIATELY STABILIZED WITH THE APPROVED ESC METHODS (E.G., SEEDING, MULCHING, PLASTER COVING, ETC.)
25. ANY AREA NEEDING ESC MEASURES NOT REQUIRING IMMEDIATE ATTENTION SHALL BE ADDRESSED WITHIN FIFTEEN (15) DAYS.
26. THE ESC FACILITIES ON ACTIVE SITES SHALL BE INSPECTED AND MAINTAINED A MINIMUM OF ONCE A MONTH OR WITHIN FORTY-EIGHT (48) HOURS OF A STORM EVENT.
27. AT NO TIME SHALL MORE THAN ONE (1) FOOT OF SEDIMENT BE ALLOWED TO ACCUMULATE WITHIN A CATCH BASIN. ALL CATCH BASINS AND CONVEYANCE LINES SHALL BE CLEANED PRIOR TO PAVING. THE CLEANING OPERATION SHALL NOT FLUSH SEDIMENT-LADEN WATER INTO THE DOWNSTREAM SYSTEM.
28. OFF-SITE STORMWATER AND/OR GROUNDWATER TO BE DIVERTED AWAY FROM SLOPES & DISTURBED AREAS WITH INTERCEPTOR DIKES, PIPES, OR SWALES. OFF-SITE STORMWATER SHALL BE MANAGED DIFFERENTLY FROM STORMWATER GENERATED ON-SITE.
29. EXCAVATED MATERIAL TO BE PLACED ON UPHILL SIDE OF TRENCH.
30. STABILIZED CONSTRUCTION ENTRANCES AND ROADS SHALL BE INSTALLED AT THE BEGINNING OF CONSTRUCTION AND MAINTAINED FOR THE DURATION OF THE PROJECT. ADDITIONAL MEASURES, SUCH AS WASH PADS, MAY BE REQUIRED TO ENSURE THAT ALL PAVED AREAS ARE KEPT CLEAN FOR THE DURATION OF THE PROJECT.
31. ANY PERMANENT FLOW CONTROL FACILITY USED AS A TEMPORARY SETTLING BASIN SHALL BE MODIFIED WITH THE NECESSARY EROSION CONTROL MEASURES AND SHALL PROVIDE ADEQUATE STORAGE CAPACITY. IF THE FACILITY IS TO FUNCTION AS AN INFILTRATION SYSTEM, THE TEMPORARY FACILITY MUST BE GRADED SO THAT THE BOTTOM AND SIDES ARE AT LEAST THREE FEET ABOVE THE FINAL GRADE OF THE PERMANENT FACILITY.
32. PRIOR TO THE BEGINNING OF THE WET SEASON (OCT. 1), ALL DISTURBED AREAS SHALL BE REVIEWED TO IDENTIFY WHICH ONES CAN BE SEDED IN PREPARATION FOR THE WINTER RAINS. DISTURBED AREAS SHALL BE SEDED WITHIN ONE WEEK OF THE BEGINNING OF THE WET SEASON. A SKETCH MAP OF THOSE AREAS TO BE SEDED AND THOSE AREAS TO REMAIN UNCOVERED SHALL BE SUBMITTED TO THE TOWN OF LA CONNER INSPECTOR. THE TOWN OF LA CONNER INSPECTOR CAN REQUIRE SEEDING OF ADDITIONAL AREAS IN ORDER TO PROTECT SURFACE WATERS, ADJACENT PROPERTIES, OR DRAINAGE FACILITIES.

ESC-2 WET SEASON SPECIAL PROVISIONS
(OCTOBER 1 • APRIL 30)

1. THE ALLOWED TIME THAT A DISTURBED AREA CAN REMAIN UNWORKED WITHOUT COVER MEASURES IS REDUCED TO TWO DAYS, RATHER THAN SEVEN.
2. STOCKPILES AND STEEP CUT AND FILL SLOPES ARE TO BE PROTECTED IF UNWORKED FOR MORE THAN 12 HOURS.
3. COVER MATERIALS SUFFICIENT TO COVER ALL DISTURBED AREAS SHALL BE STOCKPILED ON SITE.
4. ALL AREAS THAT ARE TO BE UNWORKED DURING THE WET SEASON SHALL BE SEDED WITHIN ONE WEEK OF THE BEGINNING OF THE WET SEASON.
5. MULCH IS REQUIRED TO PROTECT ALL SEDED AREAS.
6. FIFTY LINEAR FEET OF SILT FENCE (AND THE NECESSARY STAKES) PER ACRE OF DISTURBANCE MUST BE STOCKPILED ON SITE.
7. CONSTRUCTION ROAD AND PARKING LOT STABILIZED ARE REQUIRED FOR ALL SITES UNLESS THE SITE IS UNDERLAIN BY COARSE-GRAINED SOIL.
8. SEDIMENT RETENTION IS REQUIRED UNLESS NO OFFSITE DISCHARGE IS ANTICIPATED FOR THE SPECIFIED DESIGN FLOW.
9. SURFACE WATER CONTROLS ARE REQUIRED UNLESS NO OFFSITE DISCHARGE IS ANTICIPATED FOR THE SPECIFIED DESIGN FLOW.
10. PHASING AND MORE CONSERVATIVE BMP'S MUST BE EVALUATED FOR CONSTRUCTION ACTIVITY NEAR SURFACE WATERS.
11. ANY RUNOFF GENERATED BY DEWATERING SHALL BE TREATED THROUGH CONSTRUCTION OF A SEDIMENT TRAP WHEN THERE IS SUFFICIENT SPACE OR BY RELEASES THE WATER TO A WELL-VEGETATED, GENTLY SLOPING AREA. SINCE PUMPS ARE USED FOR WATERING, IT MAY BE POSSIBLE TO PUMP THE SEDIMENT-LADEN WATER WELL AWAY FROM THE SURFACE WATER SO THAT VEGETATION CAN BE MORE EFFECTIVELY UTILIZED FOR TREATMENT. A STRAW BALE FILTER SHALL BE PLACED AROUND THE DISCHARGE FROM THE DEWATERING PUMP. IF THERE IS NOT SPACE FOR A SEDIMENT TRAP OR 25 FEET OF SUITABLE VEGETATION, OTHER FILTRATION METHODS SHALL BE REQUIRED.
12. THE FREQUENCY OF MAINTENANCE REVIEW INCREASES FROM MONTHLY TO WEEKLY.
13. SOILS SHALL BE STABILIZED AT THE END OF THE SHIFT, BEFORE A HOLIDAY OR WEEKEND, IF NEEDED, BASED ON THE WEATHER FORECAST.

ESC-3 SENSITIVE AREAS SPECIAL PROVISIONS

1. WHENEVER POSSIBLE, PHASE ALL OR PART OF THE PROJECT SO THAT IT OCCURS DURING THE DRY SEASON. IF THIS IS IMPOSSIBLE, NOVEMBER THROUGH FEBRUARY SHALL BE AVOIDED SINCE THIS IS THE MOST LIKELY PERIOD FOR LARGE, HIGH-INTENSITY STORMS.
2. ALL PROJECTS SHALL BE COMPLETED AND STABILIZED AS QUICKLY AS POSSIBLE, LIMITING THE SIZE AND DURATION OF A PROJECT IS PROBABLY THE MOST EFFECTIVE FORM OF EROSION CONTROL.
3. WHERE APPROPRIATE, SANDBAGS OR AN EQUIVALENT BARRIER SHALL BE CONSTRUCTED BETWEEN THE PROJECT AREA AND THE SURFACE WATER IN ORDER TO ISOLATE THE CONSTRUCTION AREA FROM HIGH WATER THAT MIGHT RESULT DUE TO PRECIPITATION.
4. ADDITIONAL PERIMETER PROTECTION SHALL BE CONSIDERED TO REDUCE THE LIKELIHOOD OF SEDIMENT ENTERING THE SURFACE WATERS. SUCH PROTECTION MIGHT INCLUDE MULTIPLE SILT FENCES, SILT FENCES WITH A HIGHER AOS, CONSTRUCTION OF A BERM, OR A THICK LAYER OF ORGANIC MULCH UPSIDE OF A SILT FENCE.
5. IF WORK IS TO OCCUR WITHIN THE ORDINARY HIGH WATER MARK OF A STREAM, MOST PROJECTS MUST ISOLATE THE WORK AREA FROM THE STREAM BY DIVERTING THE STREAM OR CONSTRUCTING A COTTERDAM. CERTAIN SMALL PROJECTS THAT PROPOSE ONLY A SMALL AMOUNT OF GRADING MAY NOT REQUIRE ISOLATION SINCE DIVERSIONS TYPICALLY RESULT IN DISTURBANCE AND THE RELEASE OF SOME SEDIMENT TO THE STREAM FOR SUCH SMALL PROJECTS. THE PERTINENT IMPACTS FROM CONSTRUCTION WITH AND WITHOUT A DIVERSION MUST BE WEIGHED.
6. IF A STREAM MUST BE CROSSED, A TEMPORARY BRIDGE SHALL BE CONSIDERED RATHER THAN ALLOWING EQUIPMENT TO UTILIZE THE STREAMBED FOR A CROSSING.
7. ANY RUNOFF GENERATED BY DEWATERING SHALL BE TREATED THROUGH CONSTRUCTION OF A SEDIMENT TRAP WHEN THERE IS SUFFICIENT SPACE OR BY RELEASES THE WATER TO A WELL-VEGETATED, GENTLY SLOPING AREA. SINCE PUMPS ARE USED FOR DEWATERING, IT MAY BE POSSIBLE TO PUMP THE SEDIMENT-LADEN WATER WELL AWAY FROM THE SURFACE WATER SO THAT VEGETATION CAN BE MORE EFFECTIVELY UTILIZED FOR TREATMENT. A STRAW BALE FILTER SHALL BE PLACED AROUND THE DISCHARGE FROM THE DEWATERING PUMP. IF THERE IS NOT SPACE FOR A SEDIMENT TRAP OR 25 FEET OF SUITABLE VEGETATION, OTHER FILTRATION METHODS SHALL BE REQUIRED.

SEEDING

SEED MIXES: THE SEED MIXES LISTED BELOW INCLUDE RECOMMENDED MIXES FOR TEMPORARY SEEDING. THESE MIXES, WITH THE EXCEPTION OF THE WETLAND MIX, SHALL BE APPLIED AT A RATE OF 100 LBS/ACRE. THIS RATE CAN BE REDUCED IF SOIL AMENDMENTS OR SLOW RELEASE FERTILIZERS ARE USED.

TEMPORARY EROSION CONTROL SEED MIX	% WEIGHT	% PURITY	% GERMINATION
FESTUCA RUBRA VAR. COMMUTATA OR FESTUCA RUBRA ANNUAL OR PERENNIAL RYE	40	98	90
LOMELIA PILEATA OR LOMELIA PILEIFORMIS REDTOP OR COLONIA BENTGRASS	10	92	85
AGROSTIS ALBA OR AGROSTIS TENUIS HINODE OR AGROSTIS TENUIS	10	98	90
TRIPOLIUM HYBRIDUM KESTER	10	92	85

BOSWAL SEED MIX (MODIFIED BIARRACON, INC. HYDROSEEDING GUIDE WETLANDS SEED MIX)	% WEIGHT	% PURITY	% GERMINATION
TALL OR MEADOW FESCUE FESTUCA ELATIOR OR FESTUCA ELATIOR	68	98	90
SEAR'S CREEPING BENTGRASS AGROSTIS PALLIDISSIMA	10	98	85
MEADOW FOXTAIL MEADOW FOXTAIL ALEPPOGRASS PRATENSIS	10	90	80
AGROSTIS ALBA ALBOSTRIATA	6	98	90
TRIPOLIUM HYBRIDUM KESTER	6	92	85

WETLANDS SEED MIX	% WEIGHT	% PURITY	% GERMINATION
RED FESCUE FESTUCA RUBRA	35	90	90
RED FESCUE FESTUCA RUBRA	35	92	85
AGROSTIS ALBA MEADOW FOXTAIL	30	90	80
AGROSTIS ALBA ALBOSTRIATA	30	90	80

SEEDING MAINTENANCE STANDARDS


1. ANY SEDED AREAS THAT FAIL TO ESTABLISH AT LEAST 80 PERCENT COVER WITHIN ONE MONTH SHALL BE RESEDED. IF RESEEDING IS INEFFECTIVE, AN ALTERNATE METHOD, SUCH AS SODDING OR NEEDLE-PLANTING, MAY BE USED. IF WINTER WEATHER PREVENTS ADEQUATE GROWTH, THIS TIME LIMIT MAY BE RELAXED.
2. AFTER ADEQUATE COVER IS ACHIEVED, ANY AREAS THAT EXPERIENCE EROSION SHALL BE RESEDED AND PROTECTED BY MULCH.
3. SEDED AREAS SHALL BE SUPPLIED WITH ADEQUATE MOISTURE, BUT NOT WATERED TO THE EXTENT THAT IT CAUSES RUNOFF.

MULCHING

MULCH MATERIAL	QUALITY STANDARDS	APPLICATION RATES
STRAW	AIR-DRIED, FREE FROM UNDESIRABLE SEED AND COARSE MATERIAL	2"-3" THICK; 2-3 BALES 250 SF. OR 2-3 TONS PER ACRE.
WOOD FIBER CELLULOSE	NO GROWTH INHIBITING FACTORS	APPROX. 25-30 LBS. PER 1000 SF. OR APPROX. 1000-1500 LBS PER ACRE.
COMPOST	NO VISIBLE WATER OR DUST DURING HANDLING. MUST BE PURCHASED FROM SUPPLIER WITH A SOLID WASTE HANDLING PERMIT.	2" THICK MIN. APPROX. 100 TONS PER ACRE (APPROX. 800 LBS PER YARD)
CHIPPED SITE VEGETATION	AVERAGE SIZE SHALL BE SEVERAL INCHES.	2" MINIMUM THICKNESS

NOTE: MULCHING IS TO BE UTILIZED AS REQUIRED TO PREVENT EROSION AS DIRECTED BY THE ENGINEER.
MULCHING MAINTENANCE STANDARDS

1. THE THICKNESS OF THE COVER MUST BE MAINTAINED.
2. ANY AREAS THAT EXPERIENCE EROSION SHALL BE REMULCHED AND/OR PROTECTED WITH A NET OR BLANKET. IF THE EROSION PROBLEM IS DRAMATICALLY RELATED, THEN THE PROBLEM SHALL BE FIXED AND THE ERODED AREA REMULCHED.

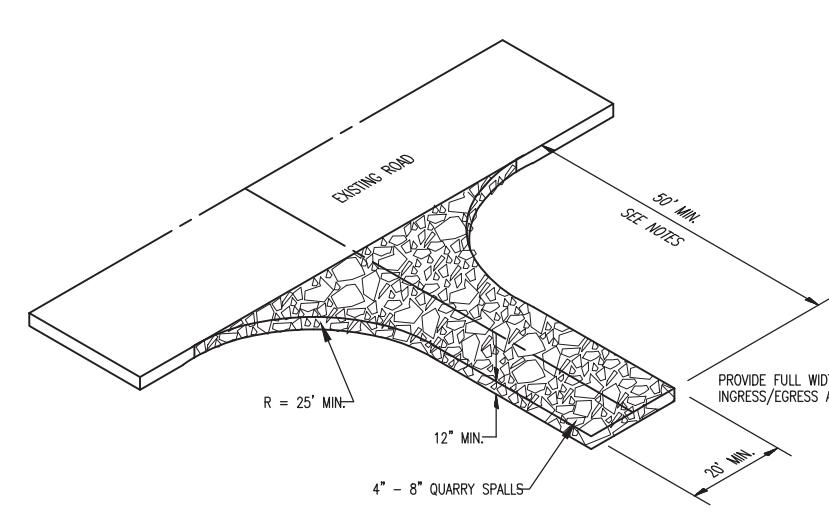


GENERAL NOTES:

1. ALL MUD AND DERRIS TRACKED ONTO EXISTING ASPHALTED ROADWAYS SHALL BE SWEEPED/CLEANED UP AFTER EACH DAY'S WORK, OR AS REQUESTED BY THE PROJECT ENGINEER AND/OR SKAGIT COUNTY ENGINEERING DEPT.


TEMPORARY CONSTRUCTION ENTRANCE MAINTENANCE STDs:

1. QUARRY SPALLS SHALL BE ADDED IF THE PAD IS NO LONGER IN ACCORDANCE WITH THE SPECIFICATIONS.
2. IF THE ENTRANCE IS NOT PREVENTING SEDIMENT FROM BEING TRACKED ONTO PAVEMENT, THEN ALTERNATIVE MEASURES TO KEEP THE STREETS FREE OF SEDIMENT SHALL BE USED. THIS MAY INCLUDE STREET SWEEPING OR AN INCREASE IN THE DIMENSIONS OF THE ENTRANCE.
3. ANY SEDIMENT THAT IS DROPPED ONTO PAVEMENT SHALL BE REMOVED IMMEDIATELY. THE PAVEMENT SHALL NOT BE CLEANED BY WASHING DOWN THE STREET, EXCEPT WHEN SWEEPING IS INEFFECTIVE AND THERE IS A THREAT TO PUBLIC SAFETY. IF IT IS NECESSARY TO WASH THE STREETS, THE CONSTRUCTION OF A SMALL SUMP OR POND SHALL BE INSTALLED ACCORDING TO THE ENGINEER'S SPECIFICATIONS.
4. ANY ROCK SPALLS THAT ARE LOOSENED FROM THE PAD AND END UP ON THE ROADWAY SHALL BE REMOVED IMMEDIATELY.
5. THE AREA OF THE ENTRANCE SHOULD BE CLEARED OF ALL VEGETATION ROOTS AND OTHER OBJECTIVE MATERIAL. THE GRAVEL SHALL BE PLACED TO THE SPECIFIED DIMENSIONS. ANY ORGANIC FACILITIES REQUIRED BECAUSE OF WASHING SHOULD BE INSTALLED ACCORDING TO MANUFACT

IN A PORTION OF THE NE QUARTER OF SECTION 36, TOWNSHIP 34 N, RANGE 02 E, W.M.

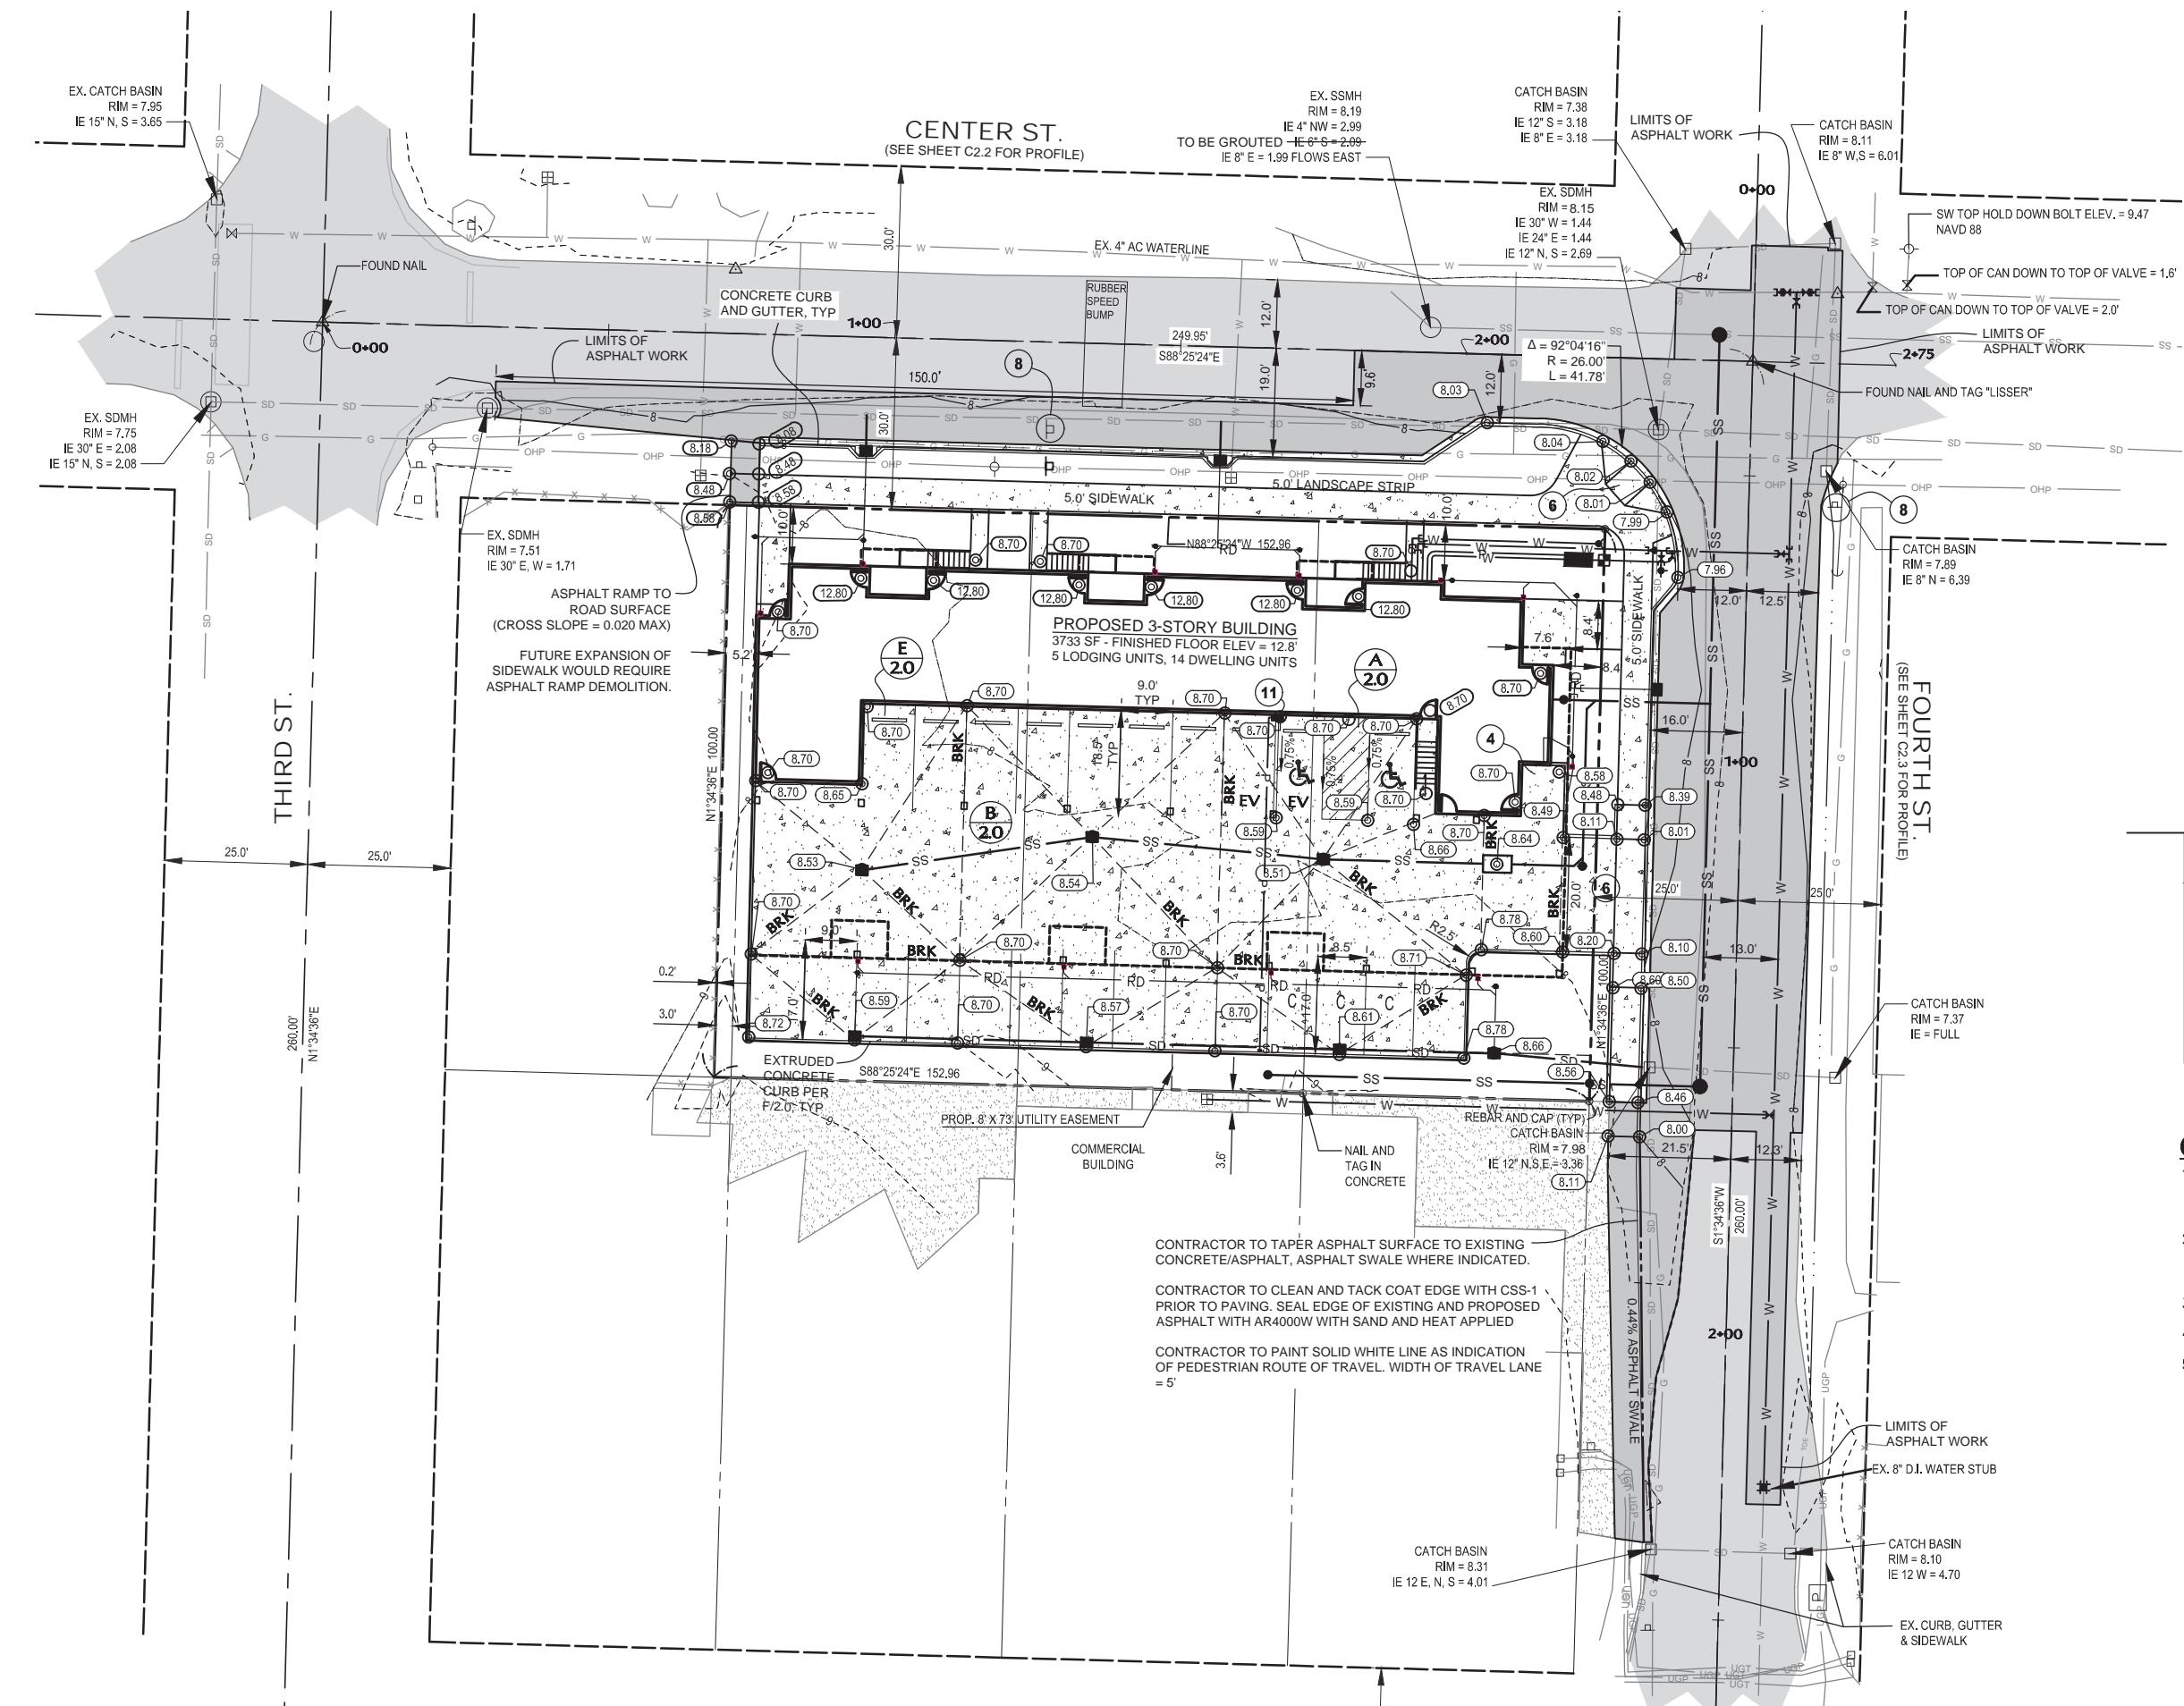


SCALE: 1" = 20'
NORTH
(NOT TO SCALE -
ORIGINAL PLOT
SIZE = 24X36")

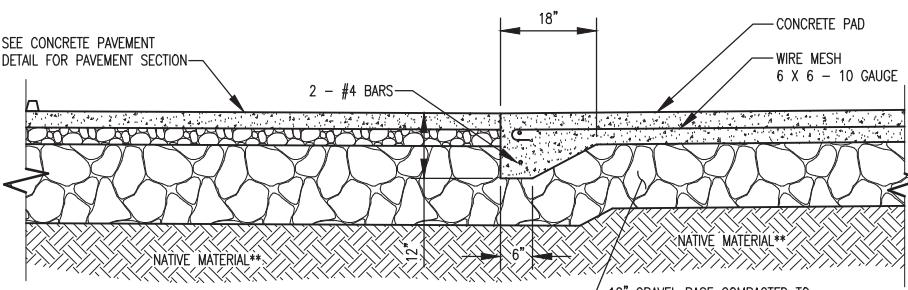


GENERAL NOTE
SEE ARCHITECTURAL PLANS FOR ENCLOSURE DETAILS AND CONSTRUCTION.

CONCRETE DUMPSTER PAD DETAIL
NOT TO SCALE (D) 2.0

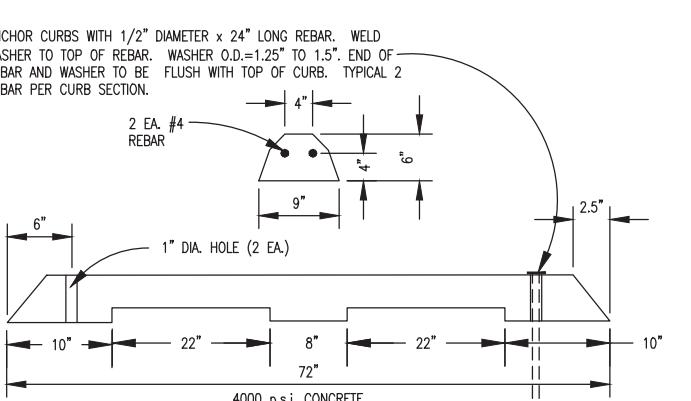

CEMENT CONCRETE PARKING CURB DETAIL
NOT TO SCALE (E) 2.0

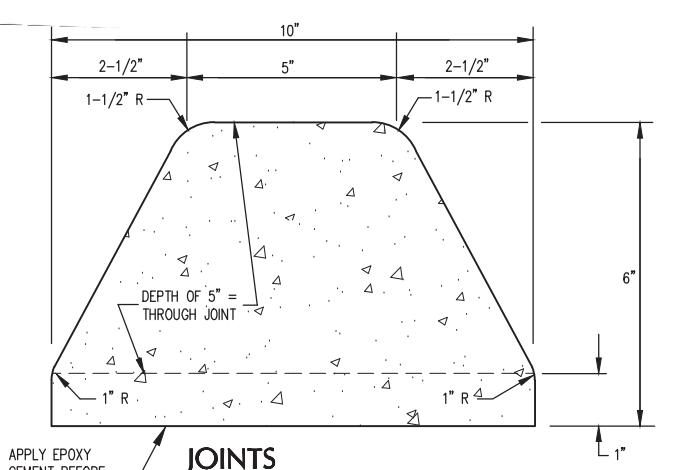


EXTRUDED CONCRETE CURB DETAIL
NOT TO SCALE (F) 2.0

LA CONNER, WASHINGTON

SHEET NOTES

1. CONTRACTOR TO PROTECT EXISTING TREES ALONG WESTERN PROPERTY LINE AND ASSOCIATED ROOT SYSTEM. THE PROJECT LANDSCAPE ARCHITECT AND/OR ARBORIST IS TO BE CONTACTED IMMEDIATELY SHOULD ANY CONCERN ARISE REGARDING THE TREES.
2. THE 5'0" LANDSCAPE STRIP BORDERING THE NORTHERN SIDEWALK IS TO NOT ADVERSELY IMPACT SIDEWALK LIGHTING. FOR ADDITIONAL DETAILS, REFER TO THE LANDSCAPE PLAN.
3. CONTRACTOR TO MINIMIZE IMPACT TO ALL FOUND MONUMENTS AND TO SCHEDULE RESTORATION OF MONUMENT(S) BY A LICENSED PROFESSIONAL LAND SURVEYOR AT THE COMPLETION OF CONSTRUCTION, AS NECESSARY AND APPROPRIATE.
4. BUILDING DIMENSIONS
PROPOSED UNITS:
GROUND LEVEL ELEV:
FINISHED FLOOR (UNIT ELEV):
SE ARCHITECTURE PLANS
5 LODGING UNITS, 14 DWELLING UNITS
8.70' IN O.C. (NO OCCUPANCY AT THIS ELEVATION)
NAV'D 88
5. BUILDING FOOTPRINT AREA:
BUILDING COVERAGE (INCL. COVERED PARKING AND OVERHANGS):
3,733 SF - 0.0857 AC
9,473 SF - 0.2175 AC
6. PARKING STALLS PROVIDED:
11 STANDARD STALLS, 3 COMPACT STALLS, 8 LONG STALLS, 2 ACCESSIBLE STALLS (24 TOTAL)
7. DUMPSTER AREA DIMENSIONS: 7.5' X 9' (CONSTRUCTED PER DETAIL D/2.0)
8. FOURTH STREET IS TO HAVE A FULL STREET ASPHALT OVERLAY WITH GRADING AS SHOWN ON PLANS. CENTER STREET IS TO HAVE A QUARTER-HALF STREET OVERLAY. OVERLAY EXTENTS ARE OUTLINED WITH SAWCUT LINES AND/OR EDGE OF ASPHALT LINES. CONTRACTOR IS TO PAVE OVERLAY AND CONSTRUCT ADDITIONAL ROAD WIDTH PER TOWN OF LA CONNER STANDARD DETAIL G3.0. CONCRETE CURB AND GUTTER PER WSDOT STANDARD PLAN F-1a.
9. CONCRETE PAVEMENT WITHIN THE PROPERTY BOUNDARY IS TO BE PER DETAIL B/2.0.
10. ALL SIDEWALKS WITHIN THE RIGHT-OF-WAY ARE TO BE CONSTRUCTED PER WSDOT STANDARD PLAN F-3 WITH A TYPE 1 DRIVEWAY ENTRANCE OFF OF FOURTH STREET PER WSDOT STANDARD PLAN F-4. PERPENDICULAR CURB RAMP AT INTERSECTION OF CENTER AND FOURTH STREET PER WSDOT STD PLAN F-40-15-04 ON SHEET C4.0
11. CONTRACTOR TO COORDINATE ALL UTILITY AND ROAD SHUT-DOWN PERIODS WITH THE TOWN OF LA CONNER. EMERGENCY DEPARTMENTS, UTILITY PURVEYORS AND APPROPRIATED PROPERTIES (RESIDENTIAL AND COMMERCIAL). CONTRACTOR TO PROVIDE TRAFFIC CONTROL PLAN, APPROVED BY THE TOWN OF LA CONNER, PRIOR TO BEGINNING CONSTRUCTION.
12. CONTRACTOR TO RELOCATE ALL EXISTING SIGNS AFFECTED BY CONSTRUCTION PER MUTCD, INCLUDING BUT NOT LIMITED TO THE "SHARE THE ROAD" AND BIKE-PEDESTRIAN DIAMOND-SHAPED SIGN ON CENTER STREET AND THE STOP SIGN IN THE SOUTHEAST CORNER OF THE CENTER AND FOURTH STREET INTERSECTION.
13. CONTRACTOR TO PAINT SKY YELLOW CENTER STRIPE ON CENTER AND FOURTH STREET, AND TO PAINT/REPAIN AFFECTED STOP BARS AT THE CENTER AND FOURTH STREET INTERSECTION, PLACED PER MUTCD.
14. CONTRACTOR TO FOLLOW TOWN OF LA CONNER'S TYPICAL TRENCH SECTION DETAIL FOR ALL TRENCH RESTORATION WORK WITHIN THE RIGHT-OF-WAY (DETAIL G1/3.0) AND SDD DETAIL E3.2 FOR ALL ON-SITE TRENCHES.
15. CONTRACTOR TO INSTALL TWO ELECTRIC VEHICLE CHARGING STATIONS AND 2' POWER CONDUIT FOR FUTURE CHARGING STATIONS PER THE ELECTRICAL PLAN

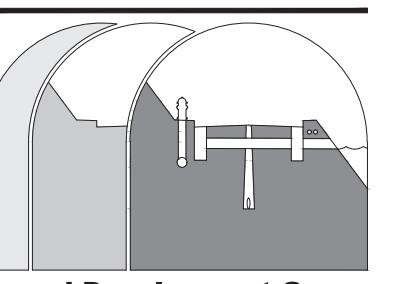

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1 9.22.23 ARCHITECT REVISION P.L.S.

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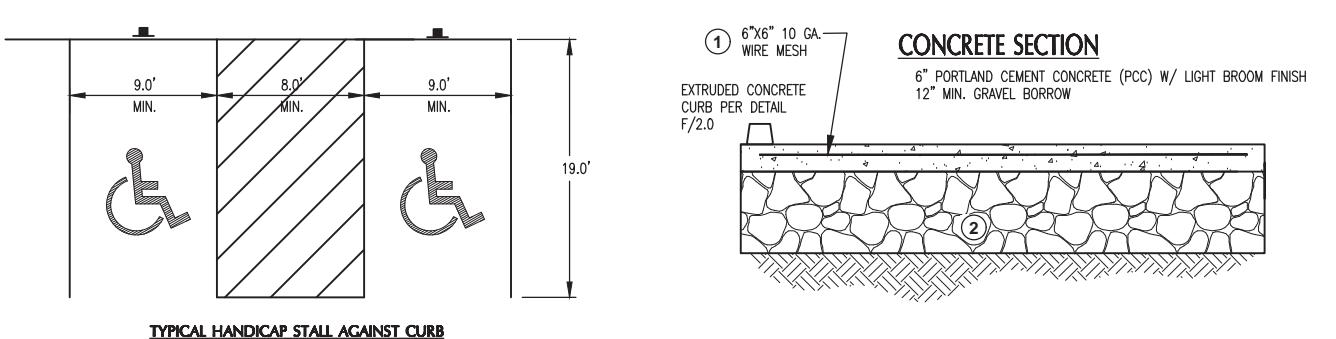
PROJECT:
CENTER STREET
MIXED-USE
FOR
KSA INVESTMENTS, LLC

SHEET DESCRIPTION:
GRADING AND
DIMENSIONAL PLAN





SCALE: 1" = 20'
DRAWN BY: C. SEVERIN
DESIGNED BY: P. SEVERIN
DATE: 08.30.2023
JOB NUMBER: 21098
DWG NAME: 21098PLN.DWG
SHEET NUMBER:

C2.0



TYPICAL HANDICAP STALL AGAINST CURB
& GUTTER OR SIDEWALK

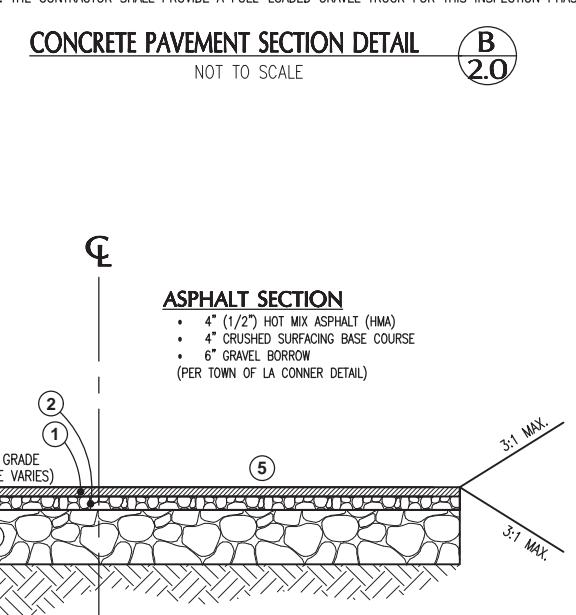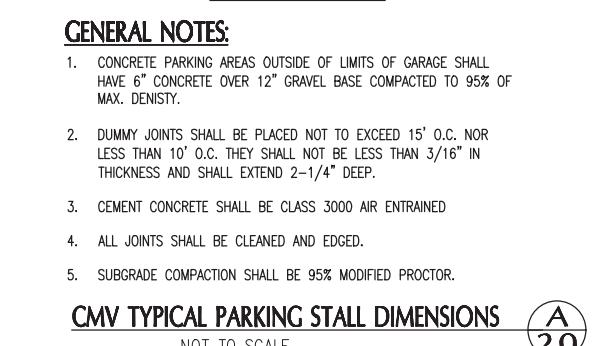


ASPHALT SECTION
• 4" (1/2") HOT MIX ASPHALT (HMA)
• 6" GRAVEL BORROW
(PER TOWN OF LA CONNER DETAIL)

GENERAL NOTES:

1. ALL CONCRETE SURFACES OUTSIDE OF LIMITS OF GARAGE SHALL HAVE 6" CONCRETE OVER 12" GRAVEL BASE COMPACTED TO 95% OF MAX. DENSITY.
2. DUMMY JOINTS SHALL BE PLACED NOT TO EXCEED 15' O.C. NOR LESS THAN 10' O.C. THEY SHALL NOT BE LESS THAN 3/16" IN THICKNESS AND SHALL EXTEND 2-1/4" DEEP.
3. CEMENT CONCRETE SHALL BE CLASS 3000 AIR ENTRAINED.
4. ALL JOINTS SHALL BE CLEANED AND EDGED.
5. SUBGRADE COMPACTION SHALL BE 95% MODIFIED PROCTOR.

TYPICAL STREET PAVEMENT SECTIONS (C) 2.0
NOT TO SCALE

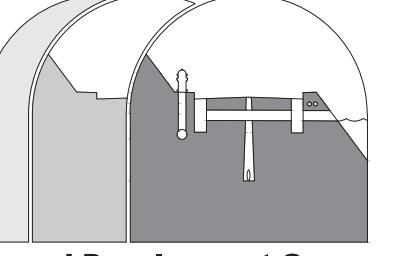

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PROJECT:
CENTER STREET
MIXED-USE
FOR
KSA INVESTMENTS, LLC

SHEET DESCRIPTION:
GRADING AND
DIMENSIONAL PLAN



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DATE: 08.30.2023
JOB NUMBER: 21098
DWG NAME: 21098PLN.DWG
SHEET NUMBER:

C2.0

IN A PORTION OF THE NE QUARTER OF SECTION 36, TOWNSHIP 34 N, RANGE 02 E, W.M. LA CONNER, WASHINGTON

A scale bar and a north arrow are shown. The scale bar is a horizontal line with tick marks. The left end is labeled '10' with an arrow pointing left. The right end is labeled '10' with an arrow pointing right. Between these ends are two tick marks, with the first one having an arrow pointing up and the second one having an arrow pointing down. Above the scale bar, the number '0' is centered. To the right of the scale bar is a circular north arrow divided into four quadrants by a crosshair. The word 'NORTH' is written in capital letters to the right of the arrow.

CENTER ST

** NOTE: CONTRACTOR TO VERIFY ALL
INVERTS, PIPE SIZES AND UTILITY
LOCATIONS IN FIELD AND NOTIFY
ENGINEER IMMEDIATELY SHOULD
DISCREPANCIES OR CONFLICTS OCCUR

EX SSMH 1
EX. SSMH
RIM = 8.19
IE 4" NW = 2.99
IE 6" S = 2.09
IE 8" E = 1.99 FLOWS EAST

EX SDMH

1000

— — —

0.00

1

1

— — — — —

SHEET RE
NO. DATE
1 9.22.23

VISIONS: DESCRIPTION ARCHITECT

W
REVISION

APPROV
P.

ED
L.S.



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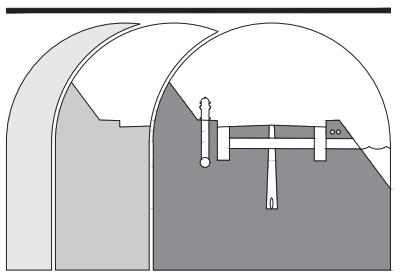
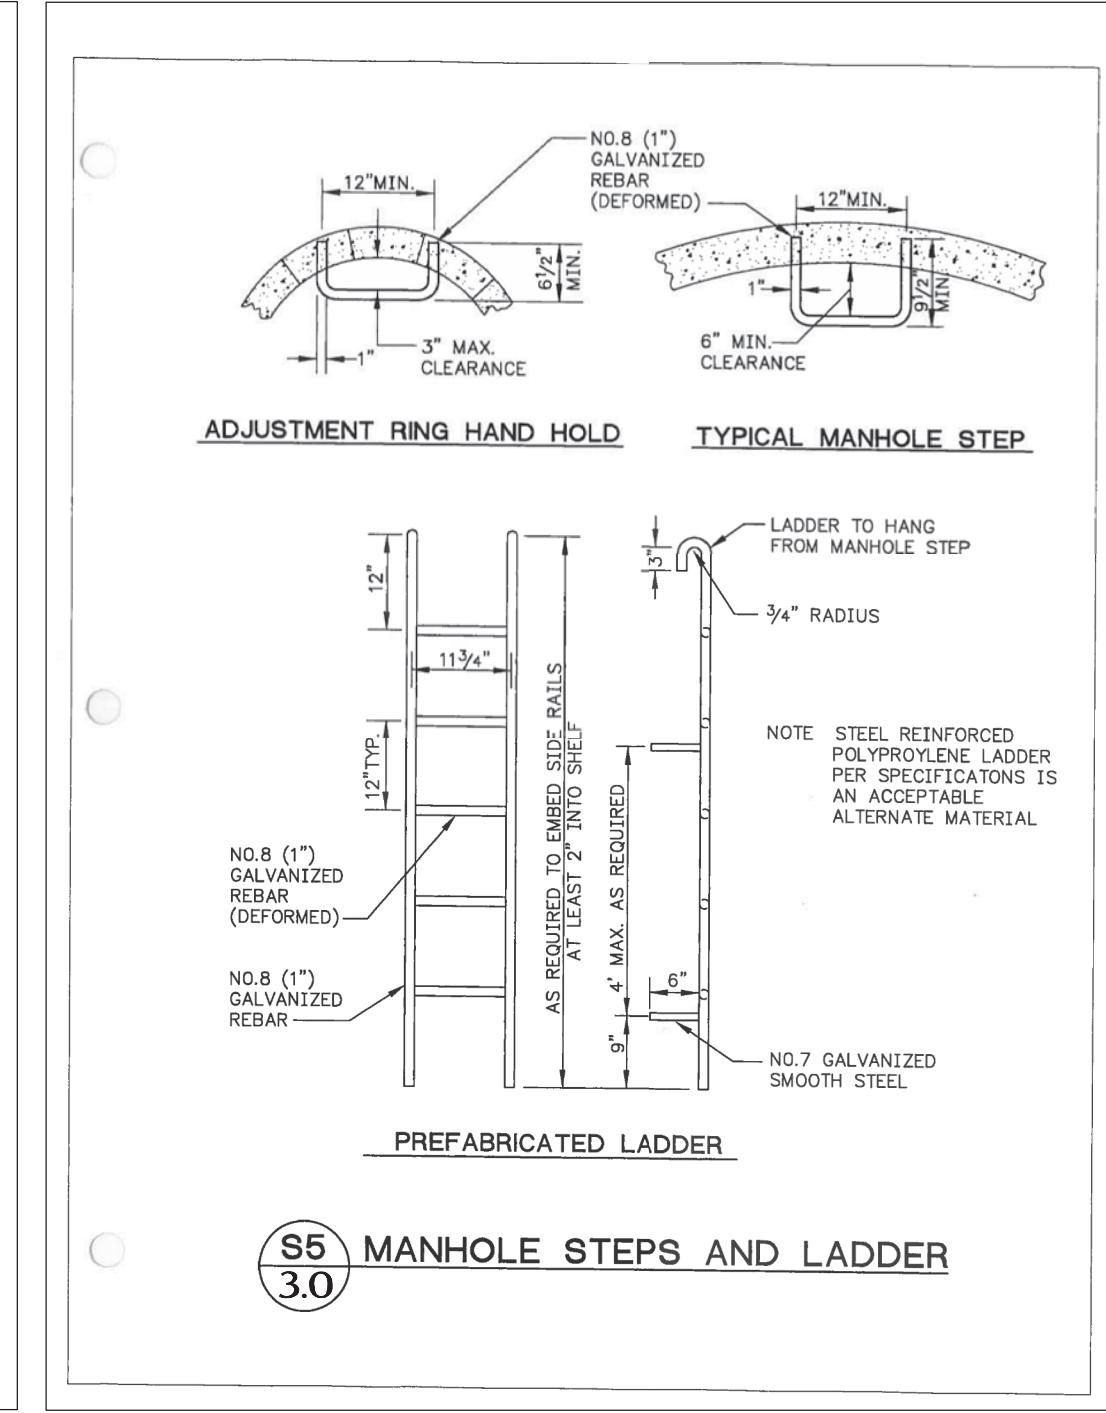
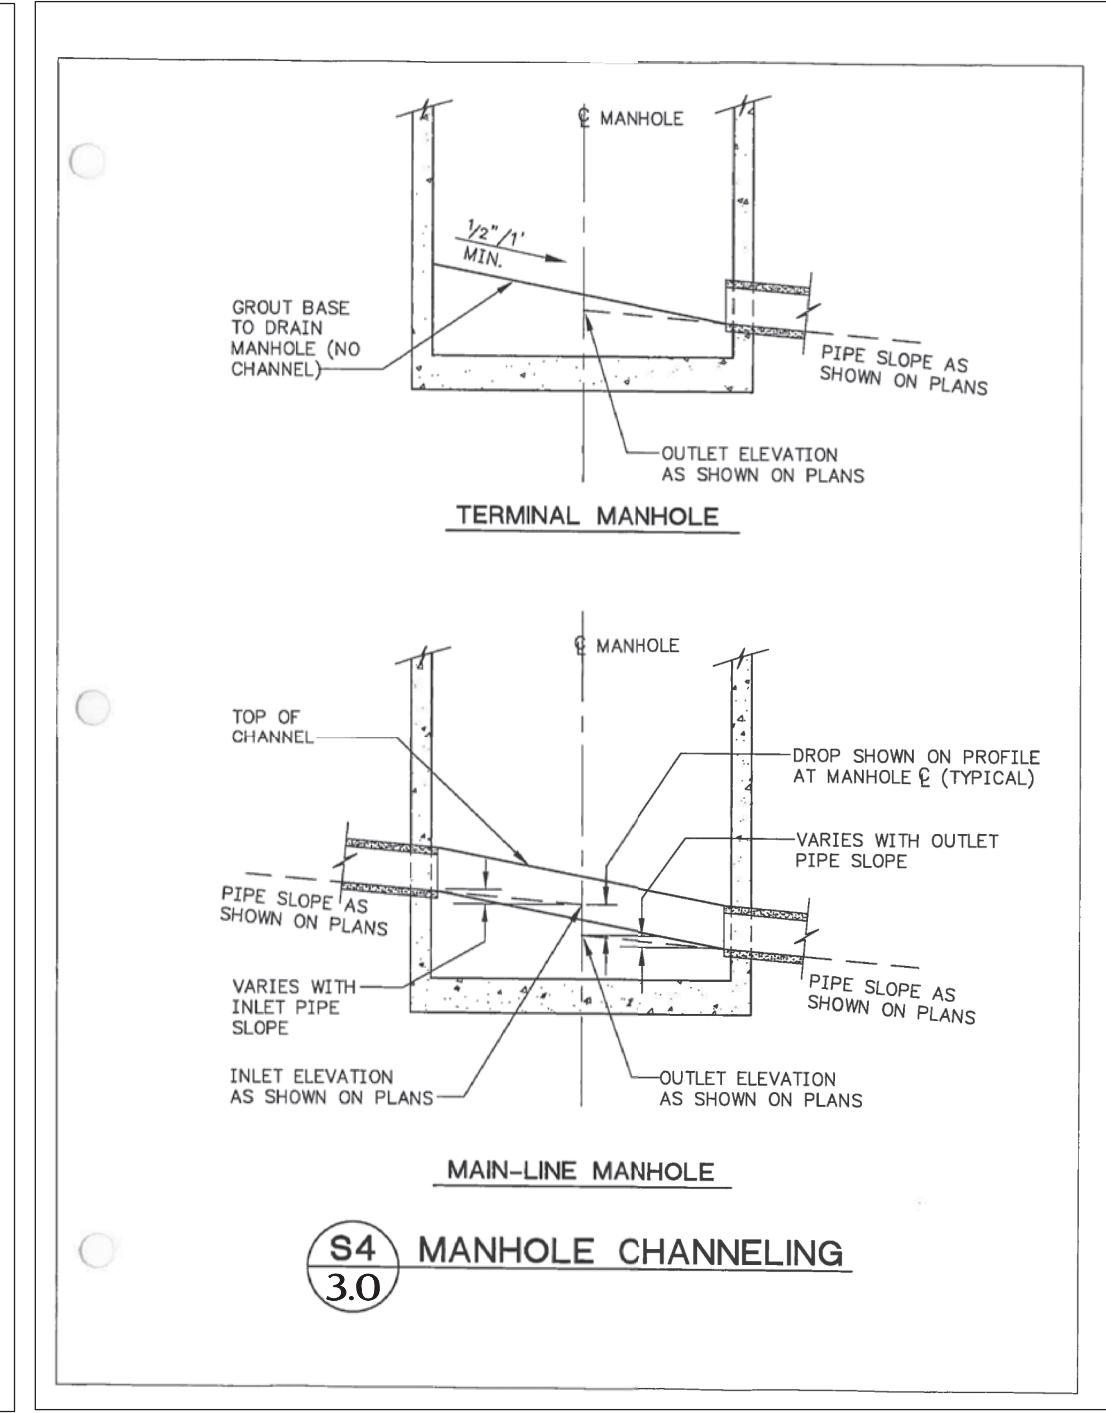
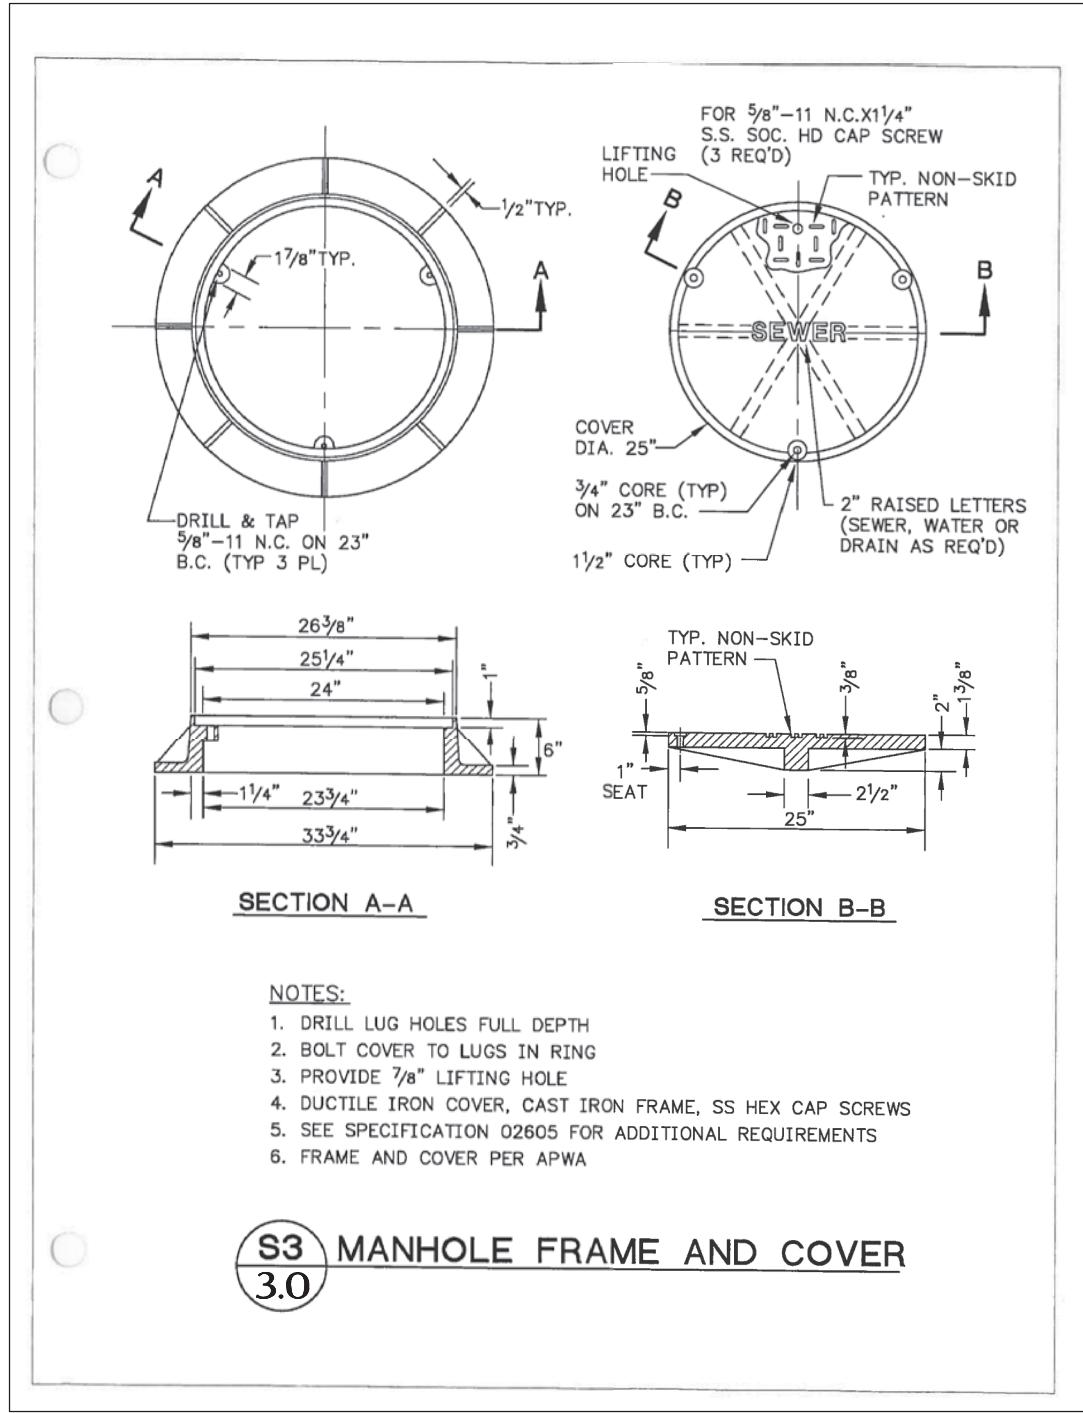
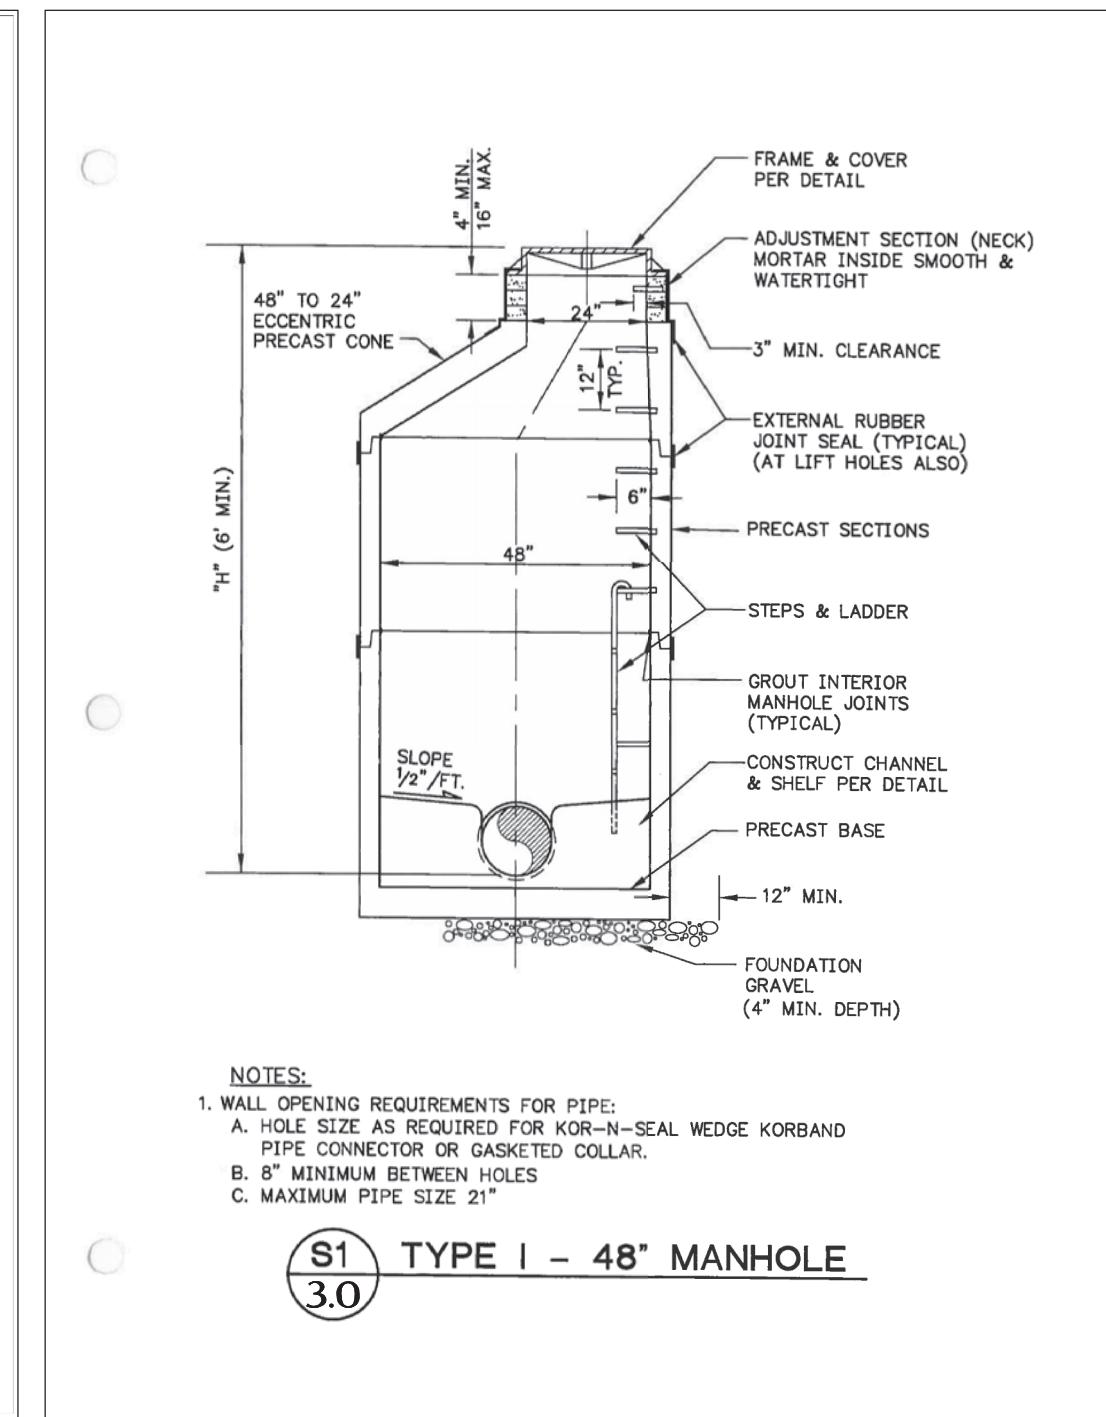
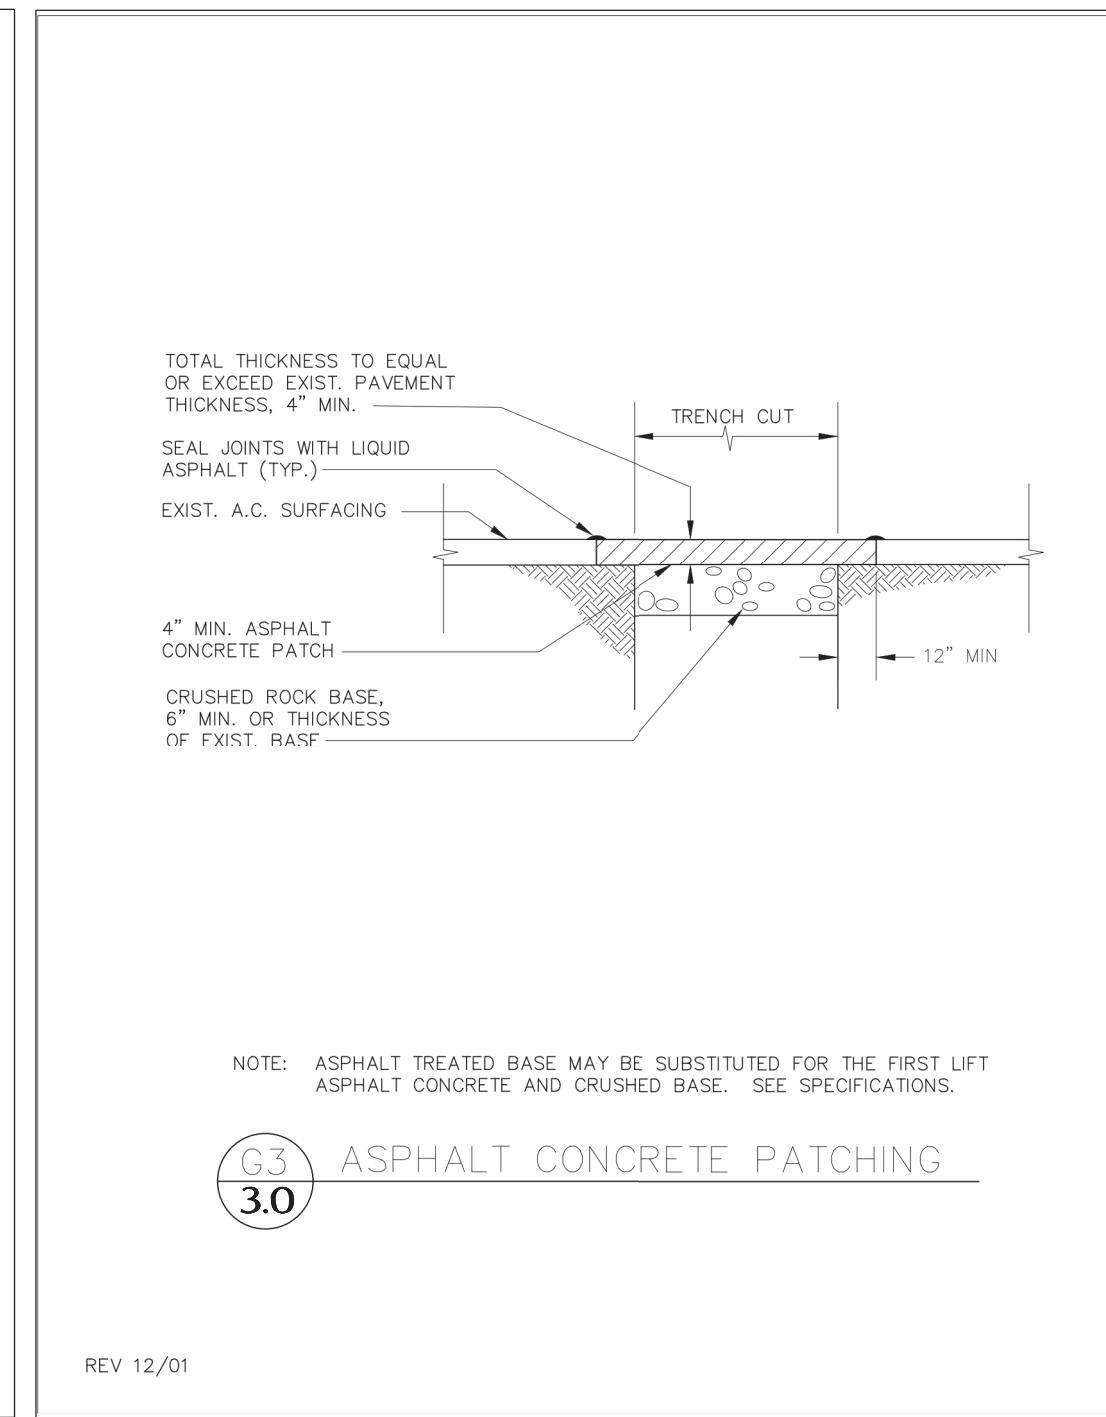
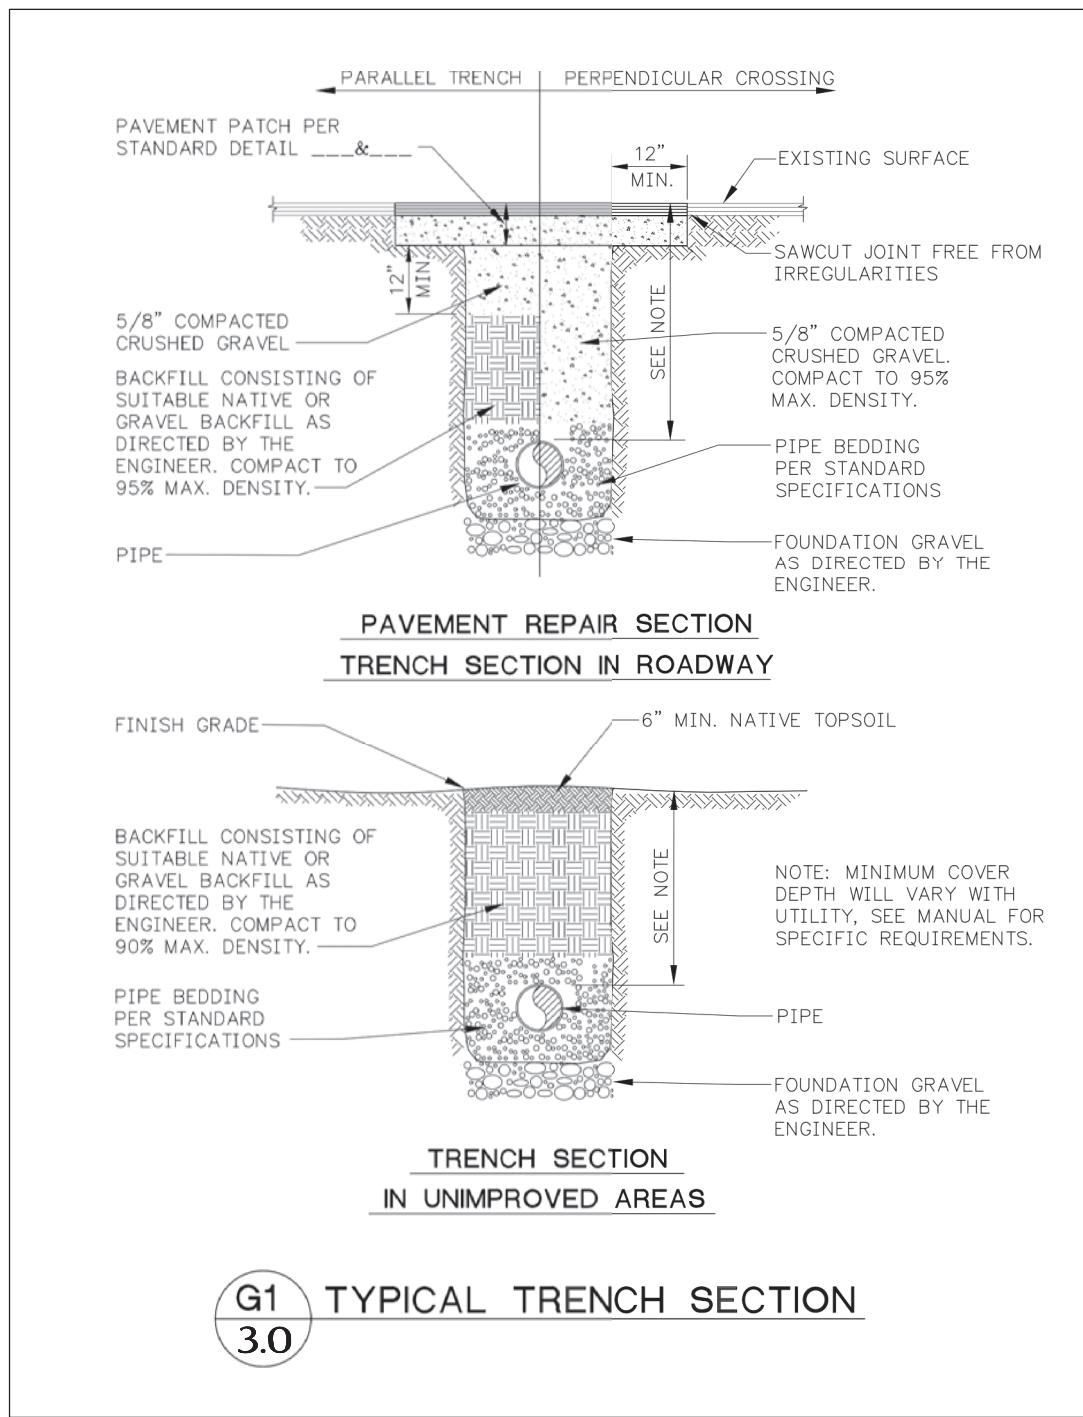
PROJECT: **KSA INVESTMENT
CENTER STR
MIXED-US
FOR**

SHEET DESCRIPTION: **CENTER STREET
ROADWAY IMPROVEMENT
PLAN & PROFILE**

SCALE:	AS NOTED
DRAWN BY:	C.SEVERIN
DESIGNED BY:	P.SEVERIN
DATE:	08.30.2023
JOB NUMBER:	21098
DWG NAME:	21098PLN.DWG
SHEET NUMBER:	

C2.2



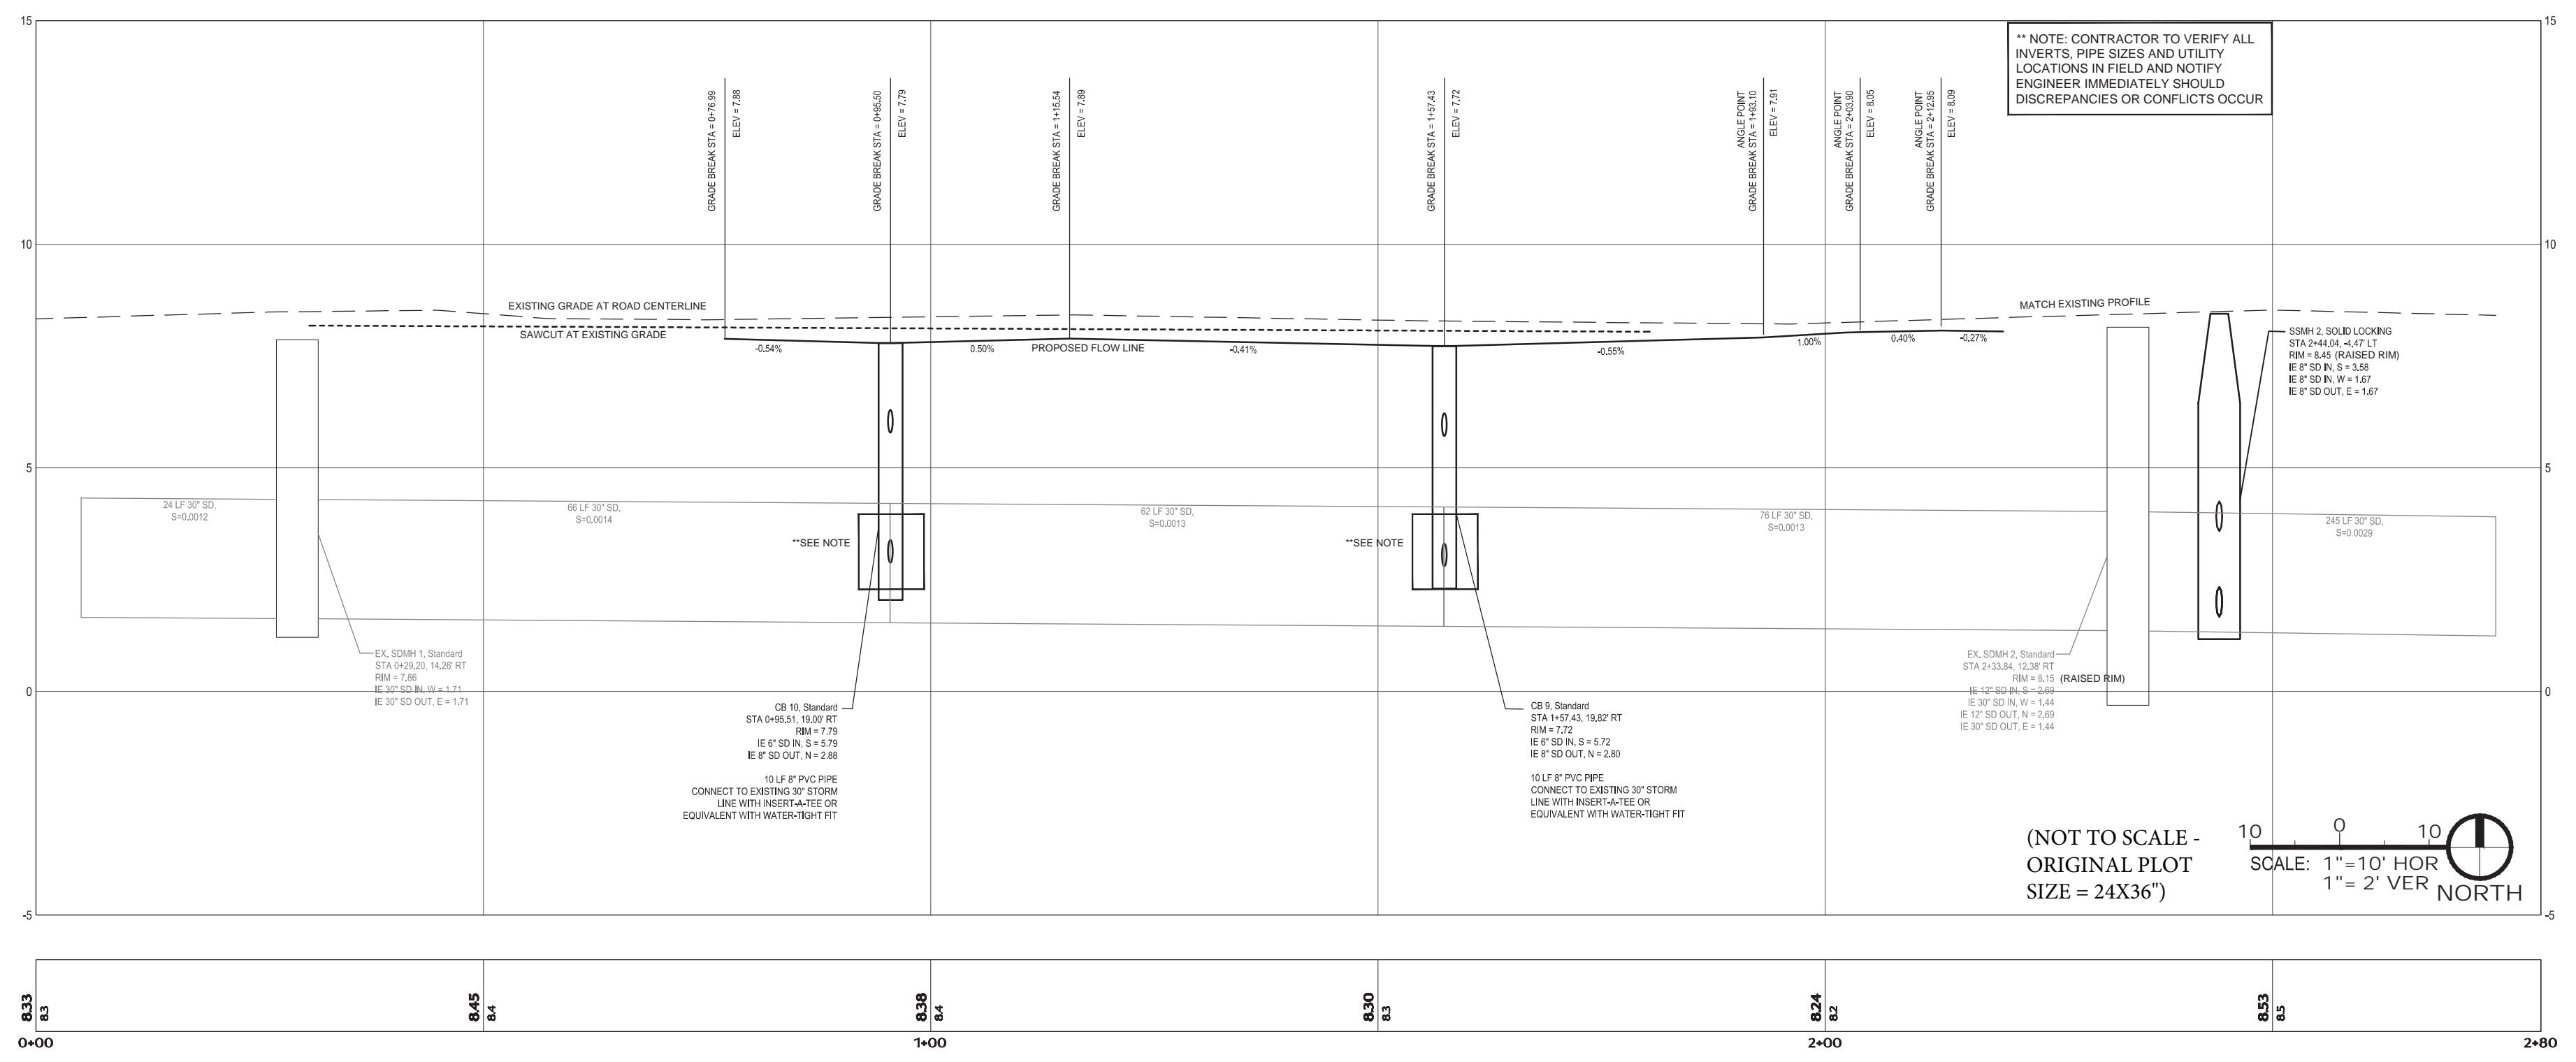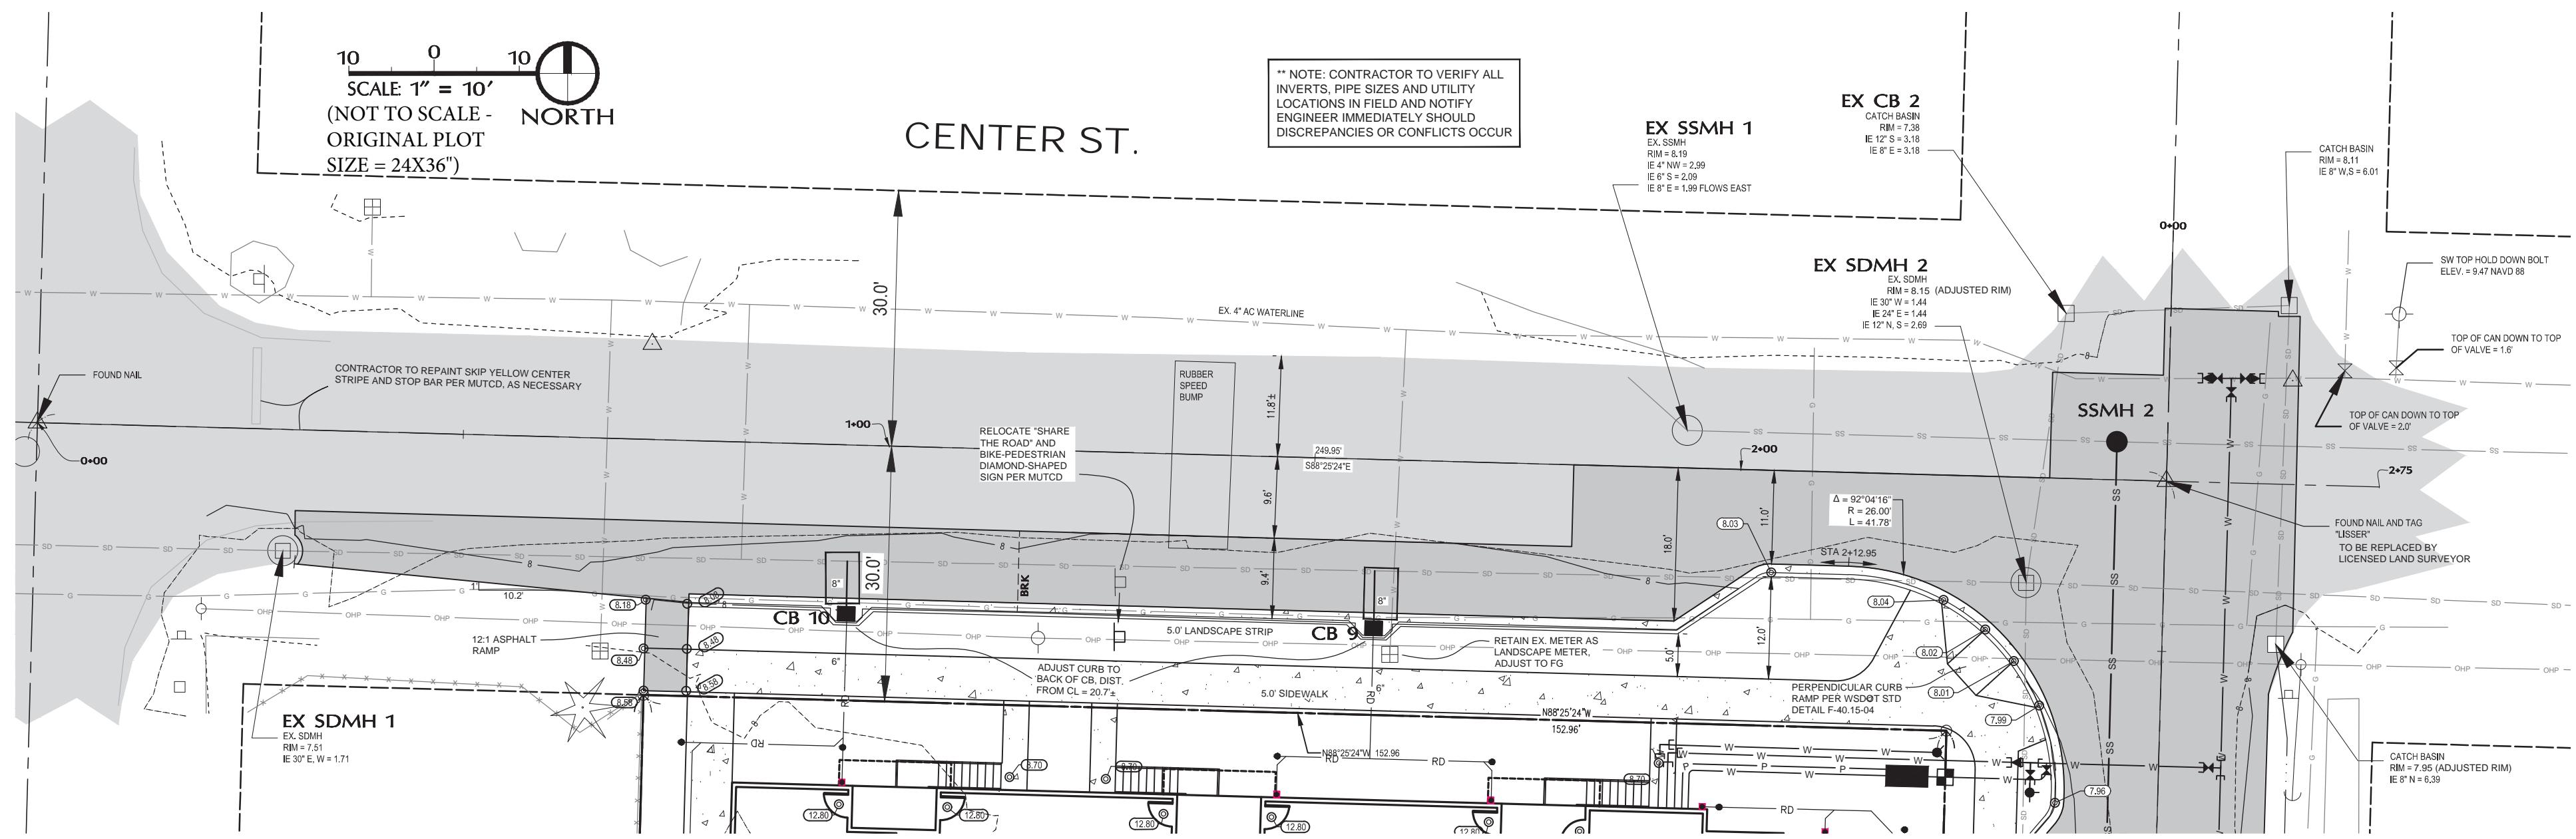

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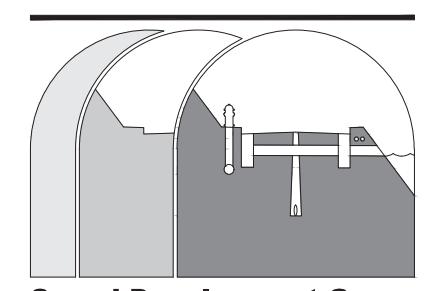
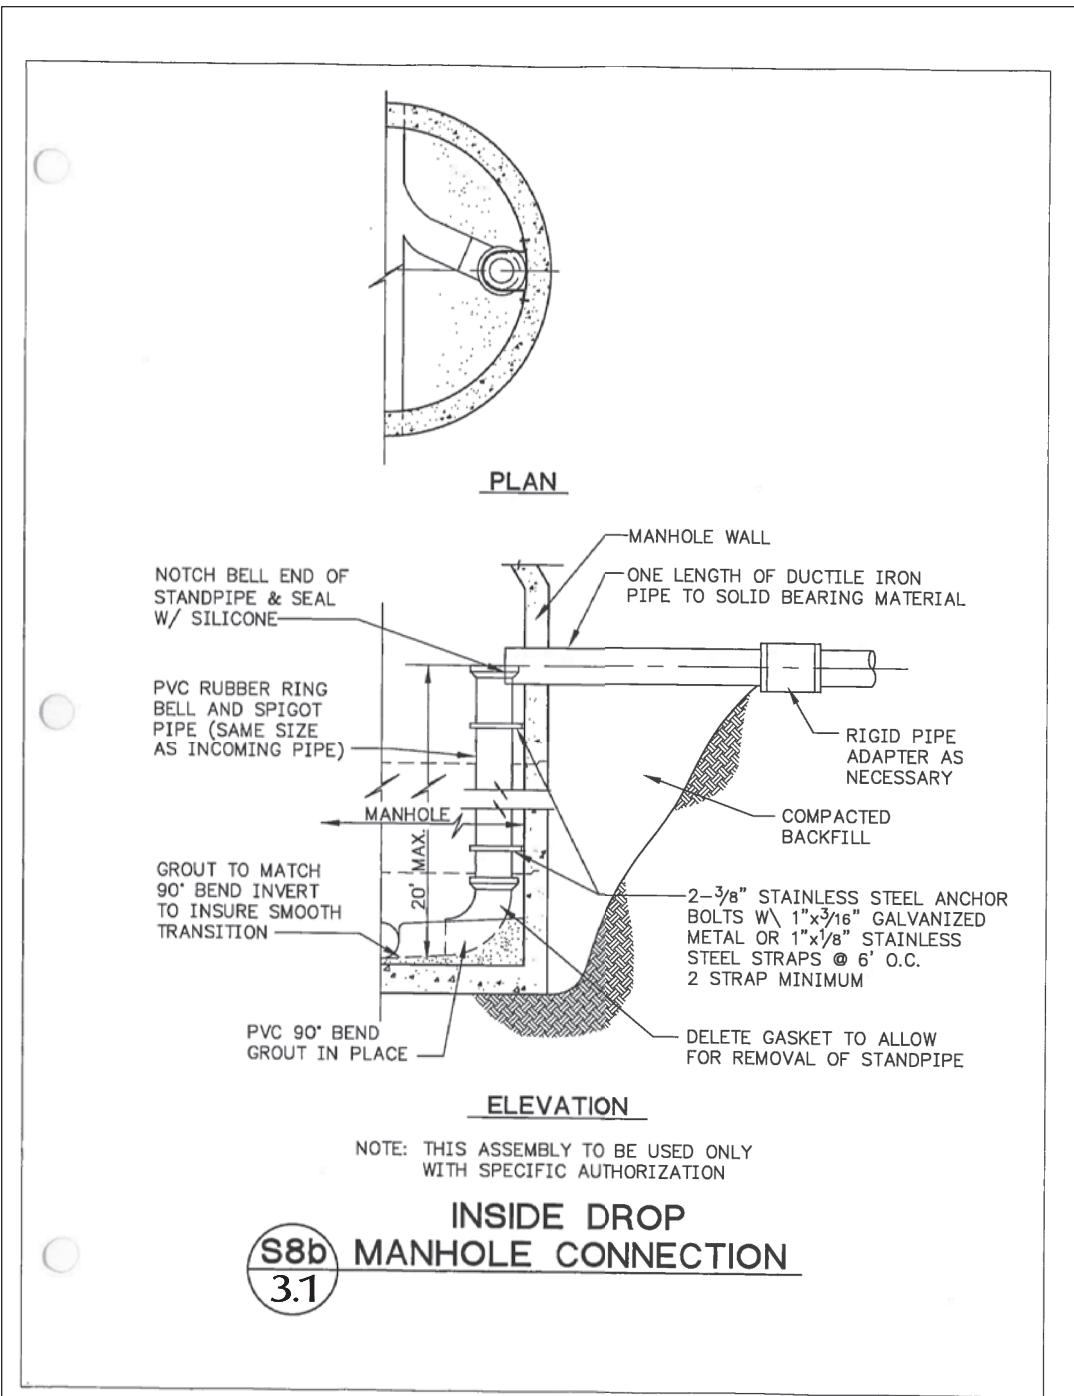
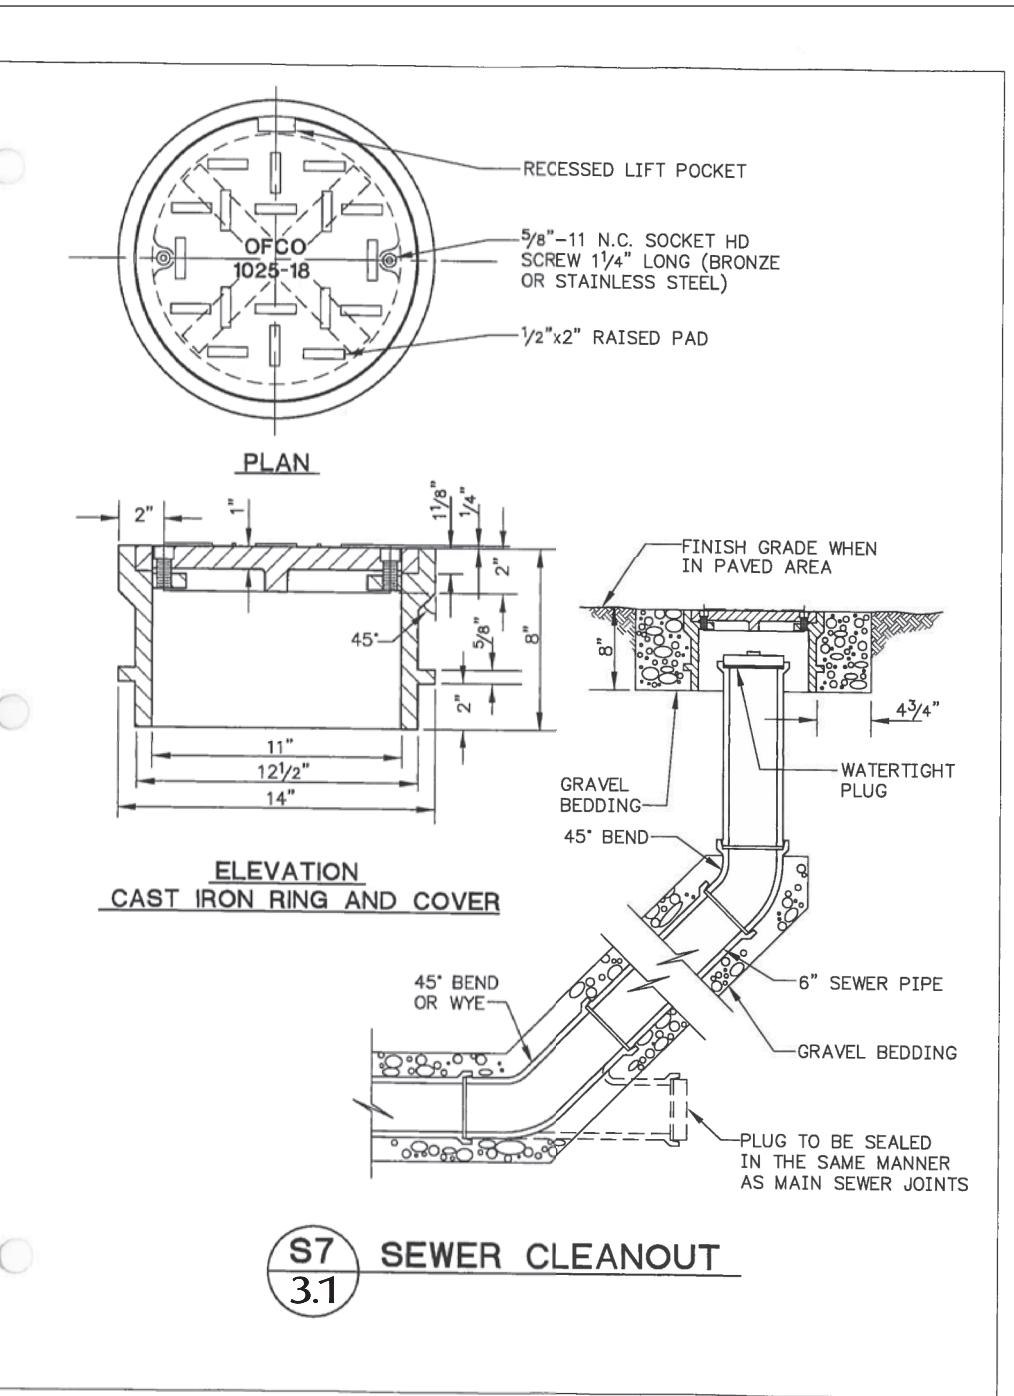
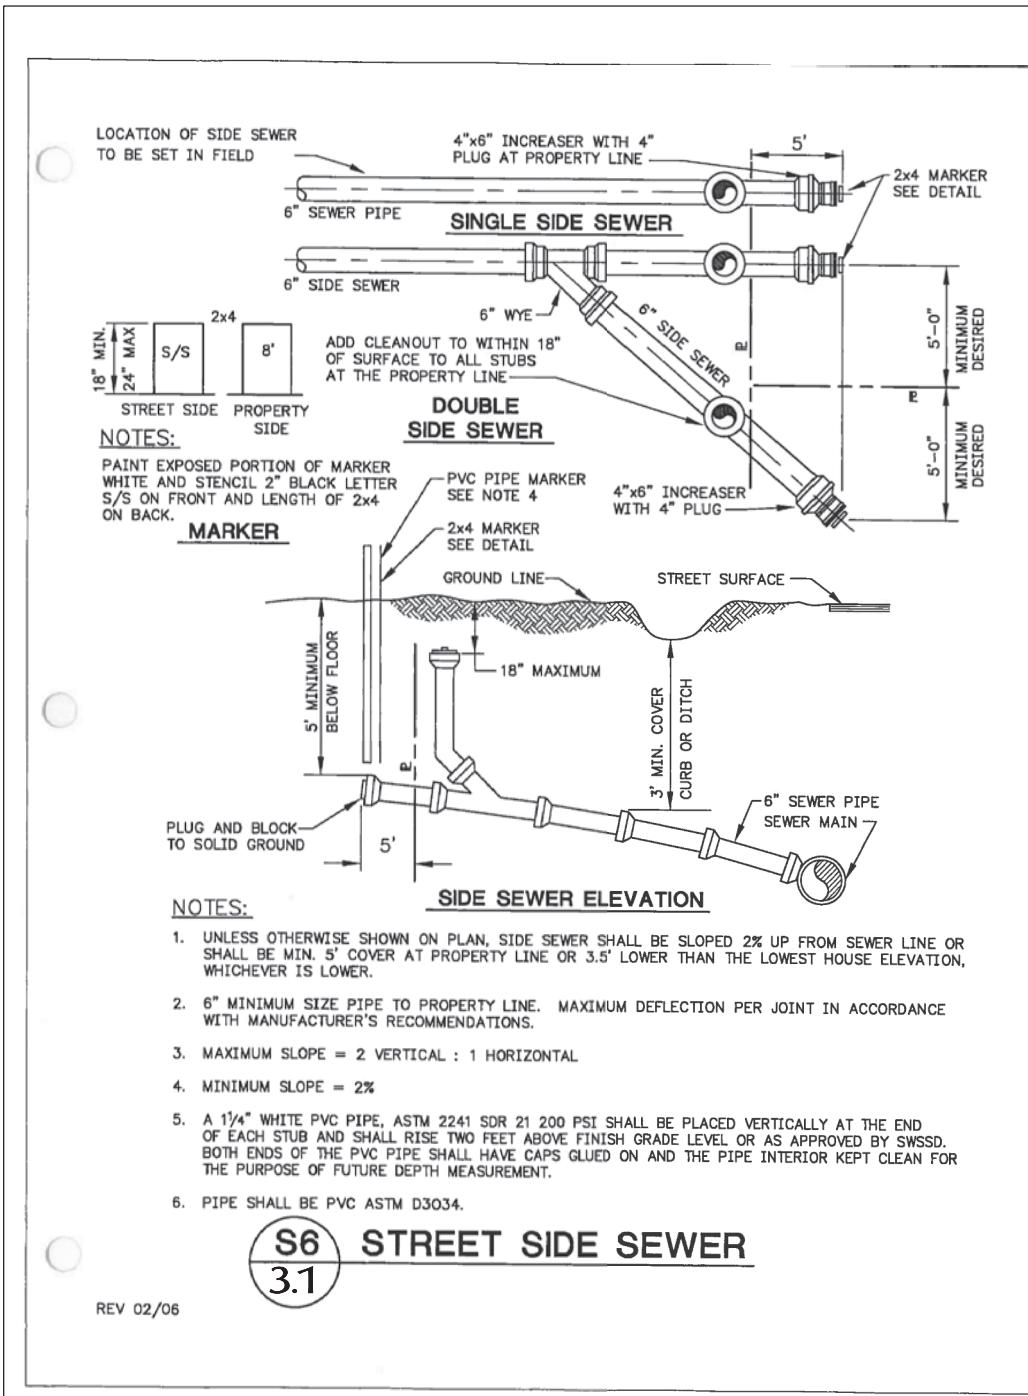
PROJECT:
CENTER STREET
MIXED-USE
FOR
KSA INVESTMENTS, LLC

SHEET DESCRIPTION:
SITE & SEWER DETAILS



SCALE: AS NOTED
DRAWN BY: C. SEVERIN
DESIGNED BY: P. SEVERIN
DATE: 08.30.2023
JOB NUMBER: 21098
DWG NAME: 21098PLN.DWG
SHEET NUMBER:

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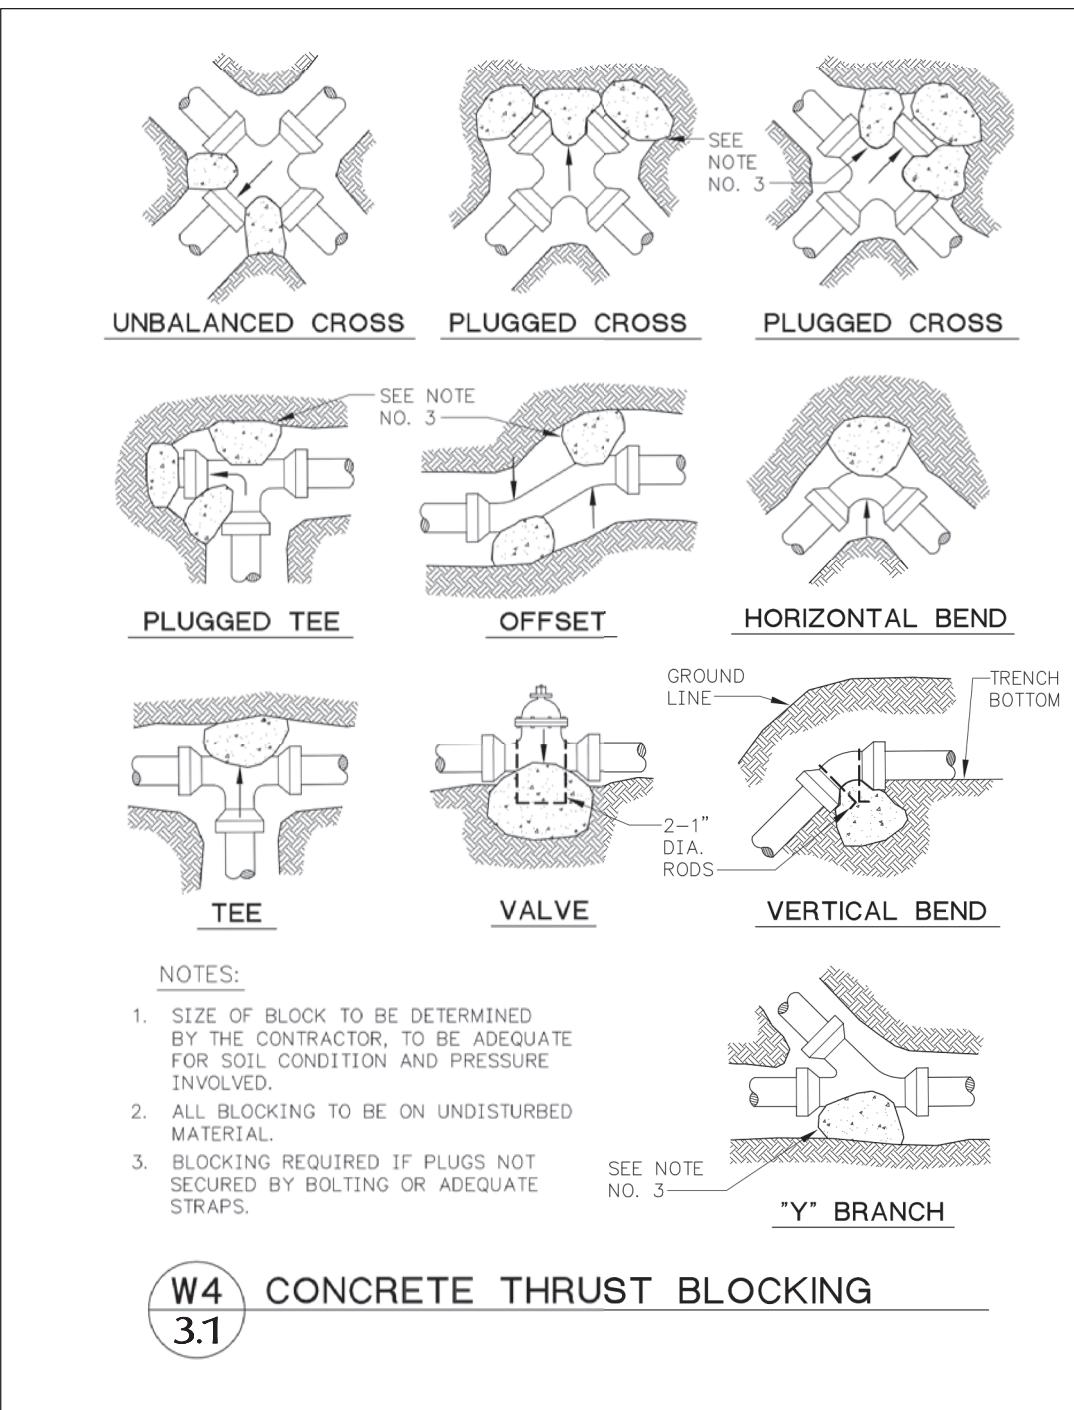
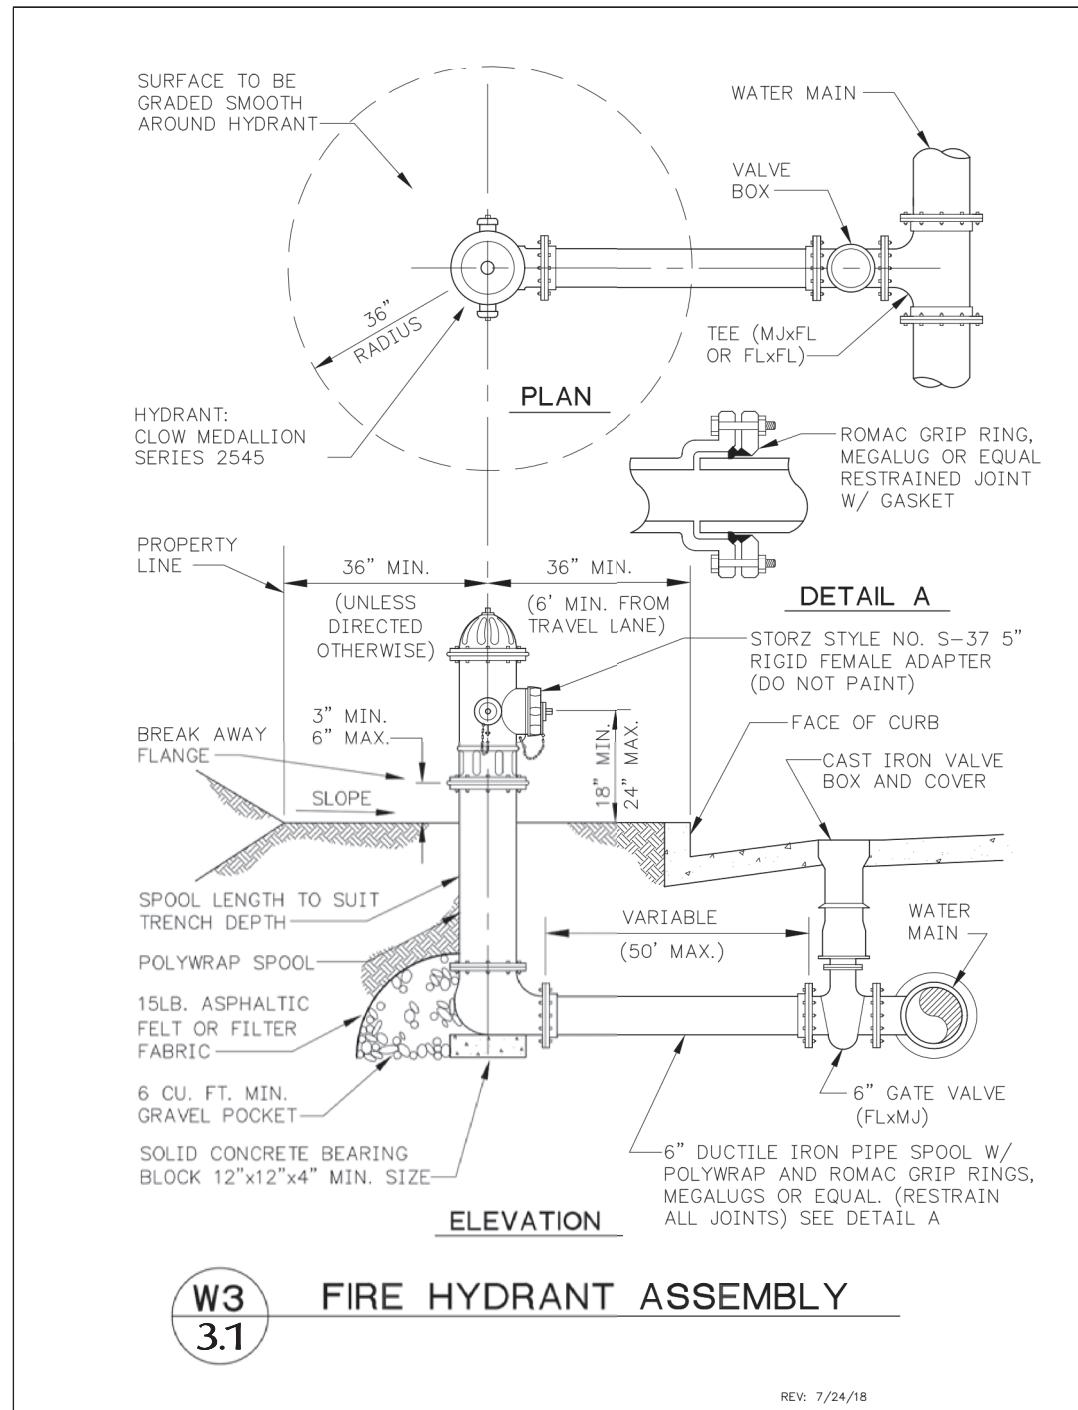
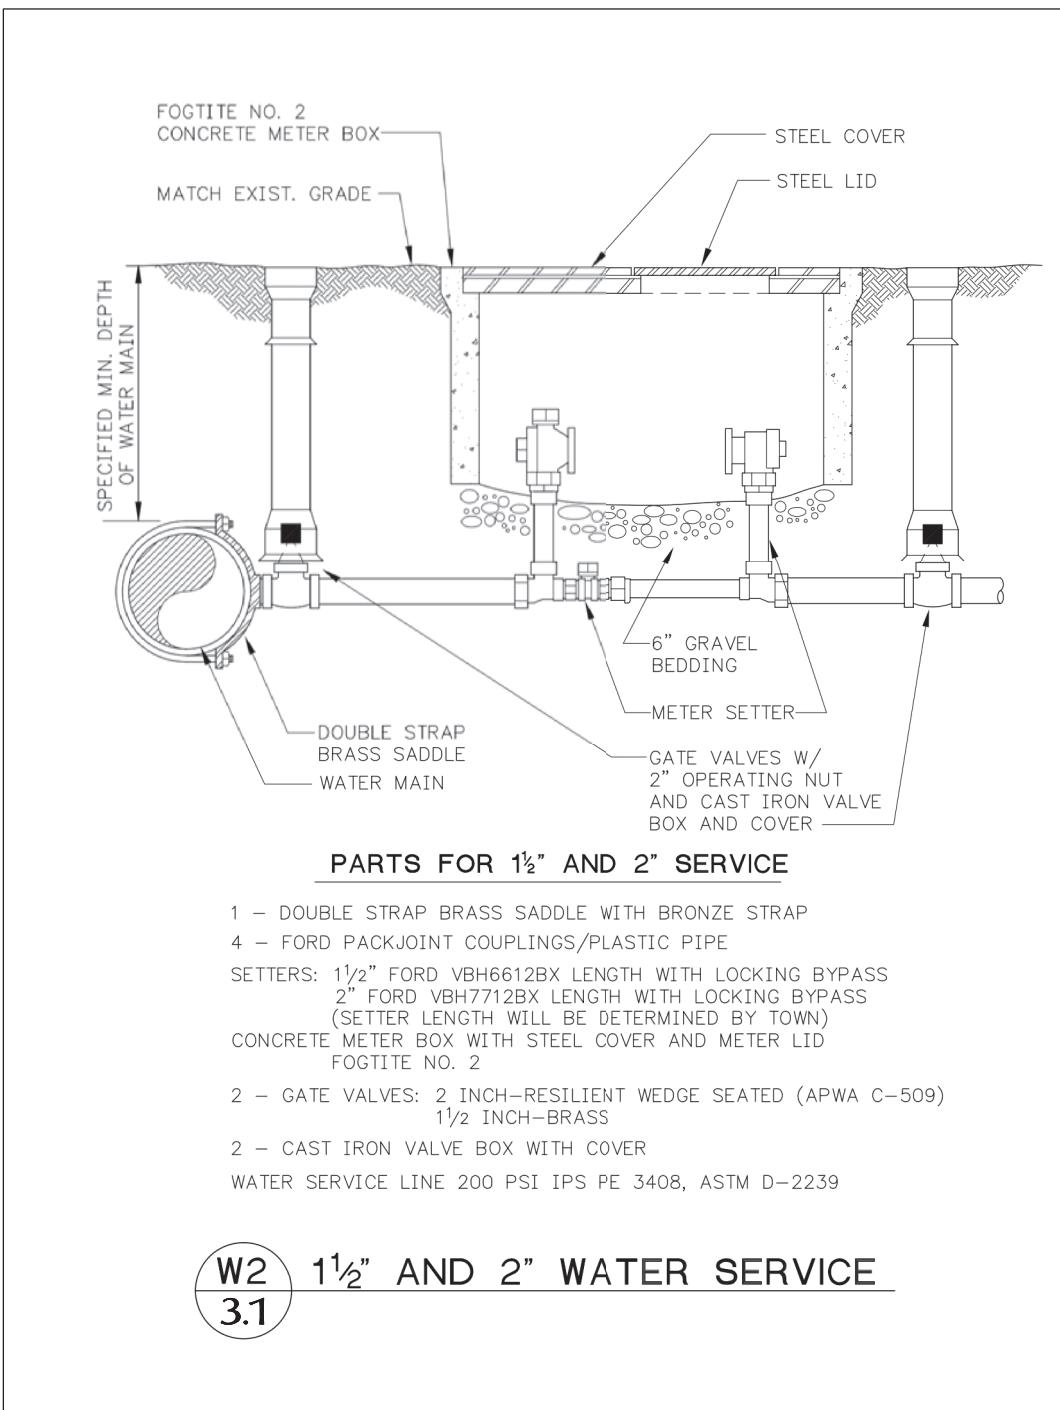
PROJECT:
**CENTER STREET
MIXED-USE**
FOR
KSA INVESTMENTS, LLC








SHEET DESCRIPTION:
SEWER & WATER DETAILS



SCALE: AS NOTED
DRAWN BY: C. SEVERIN
DESIGNED BY: P. SEVERIN
DATE: 08.30.2023
JOB NUMBER: 21098
DWG NAME: 21098PLN.DWG
SHEET NUMBER:

C3.1



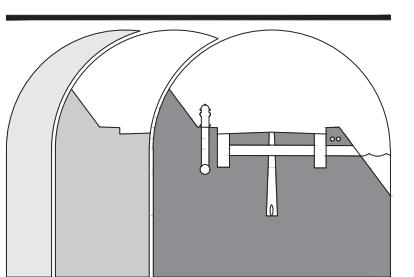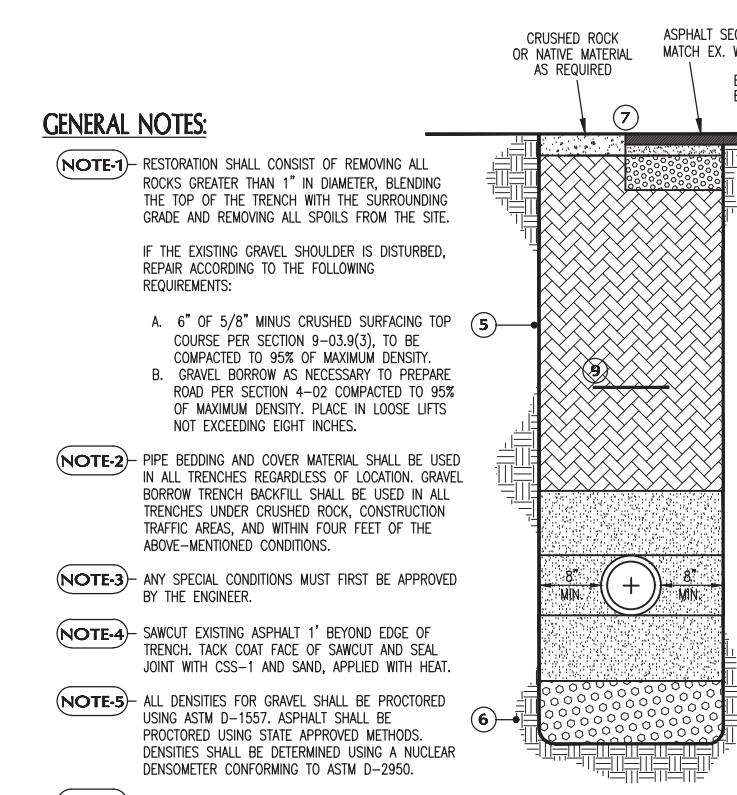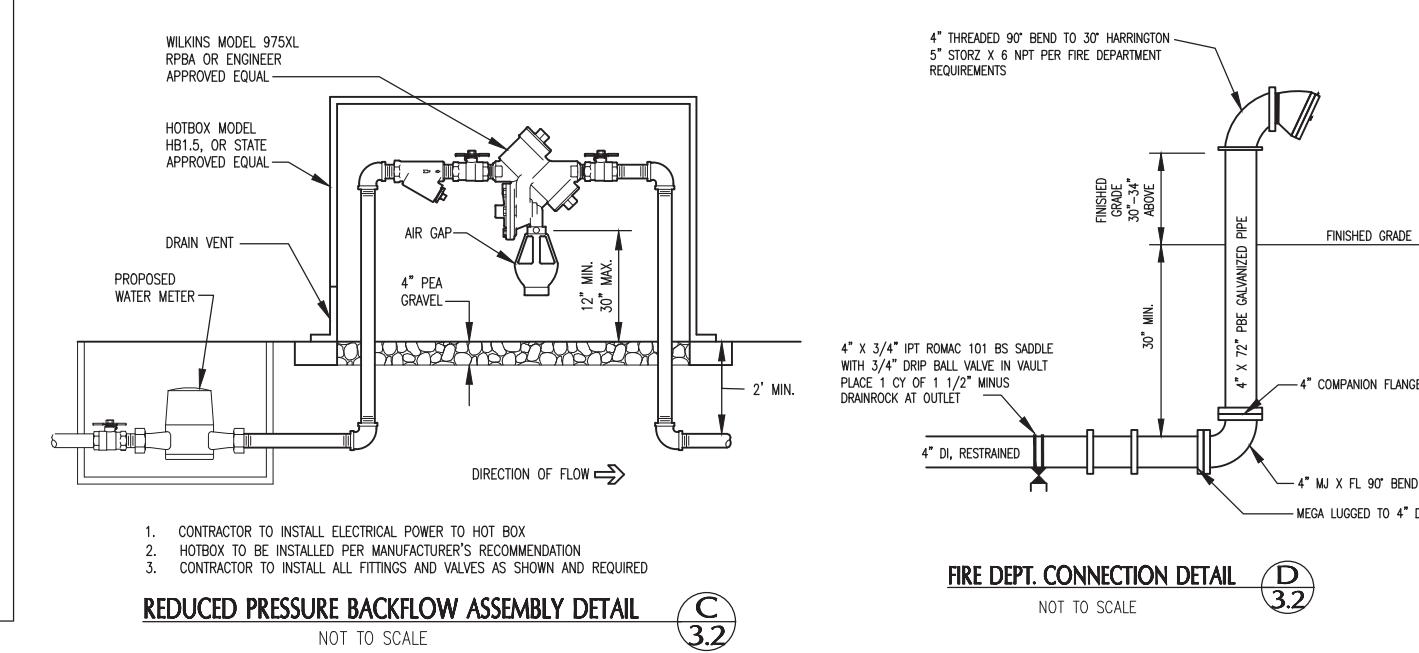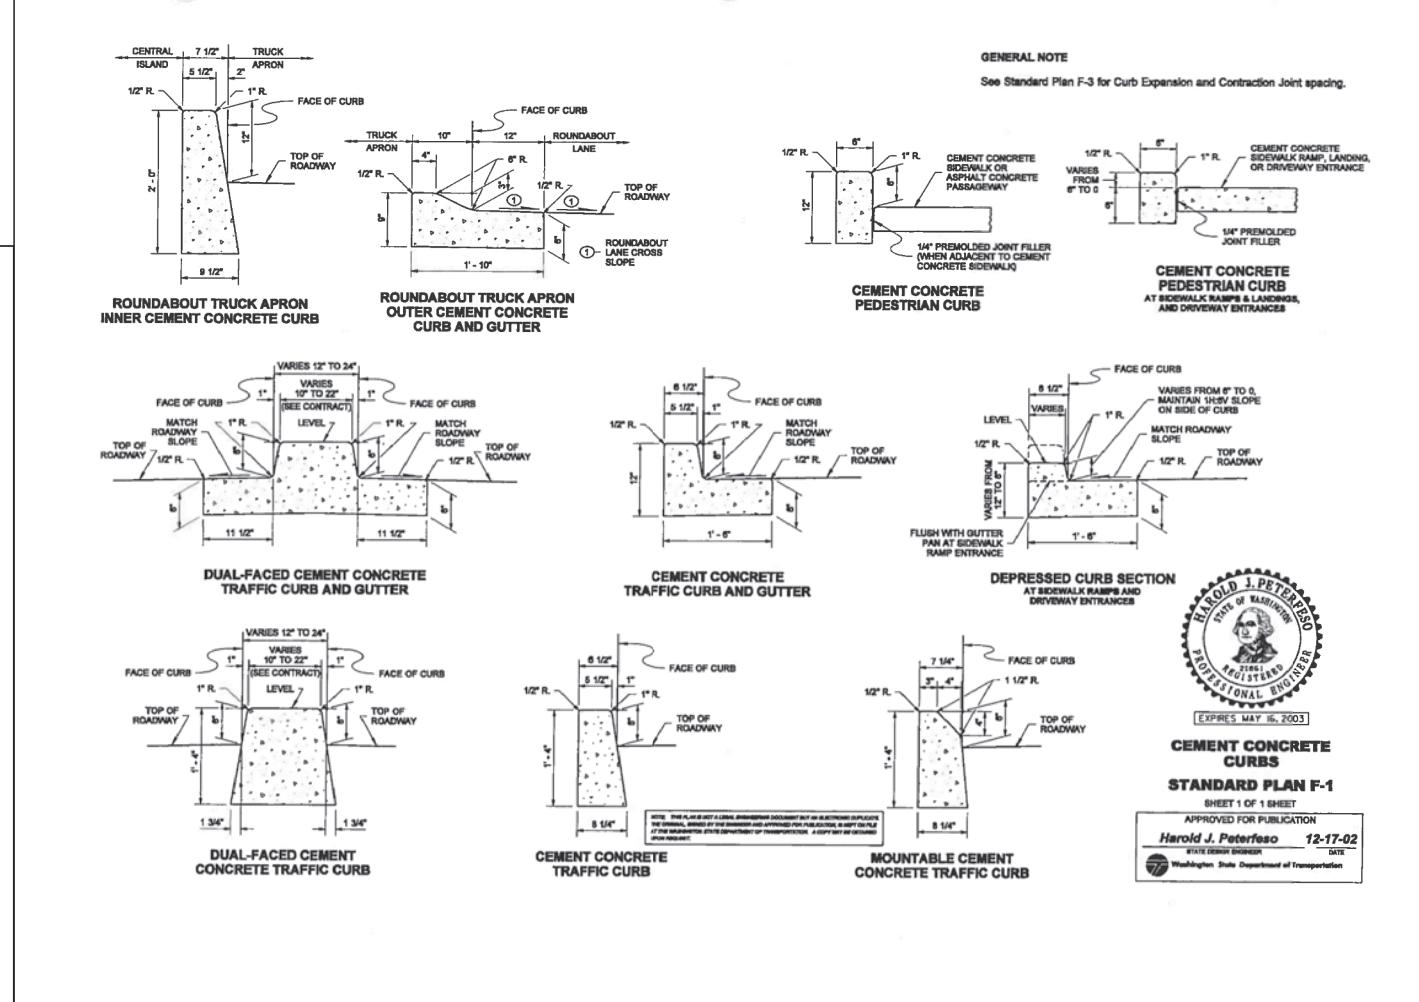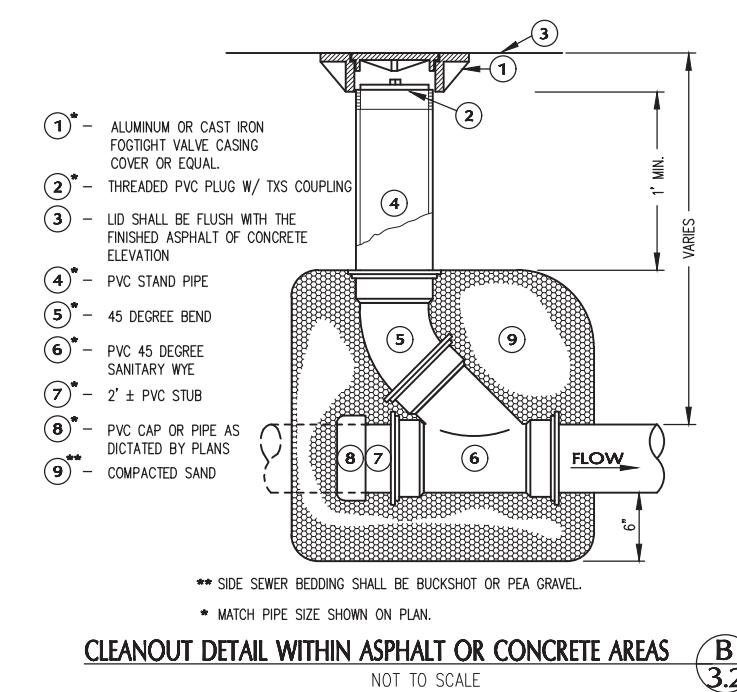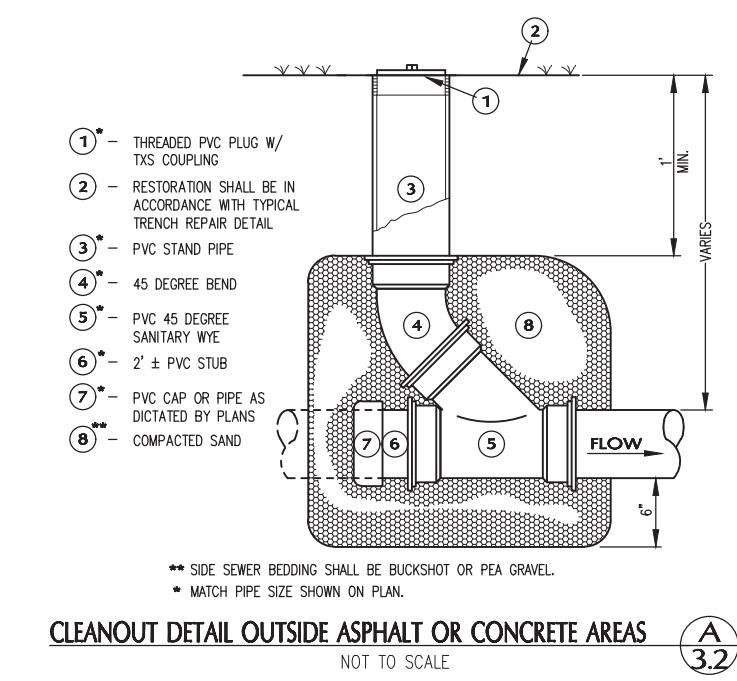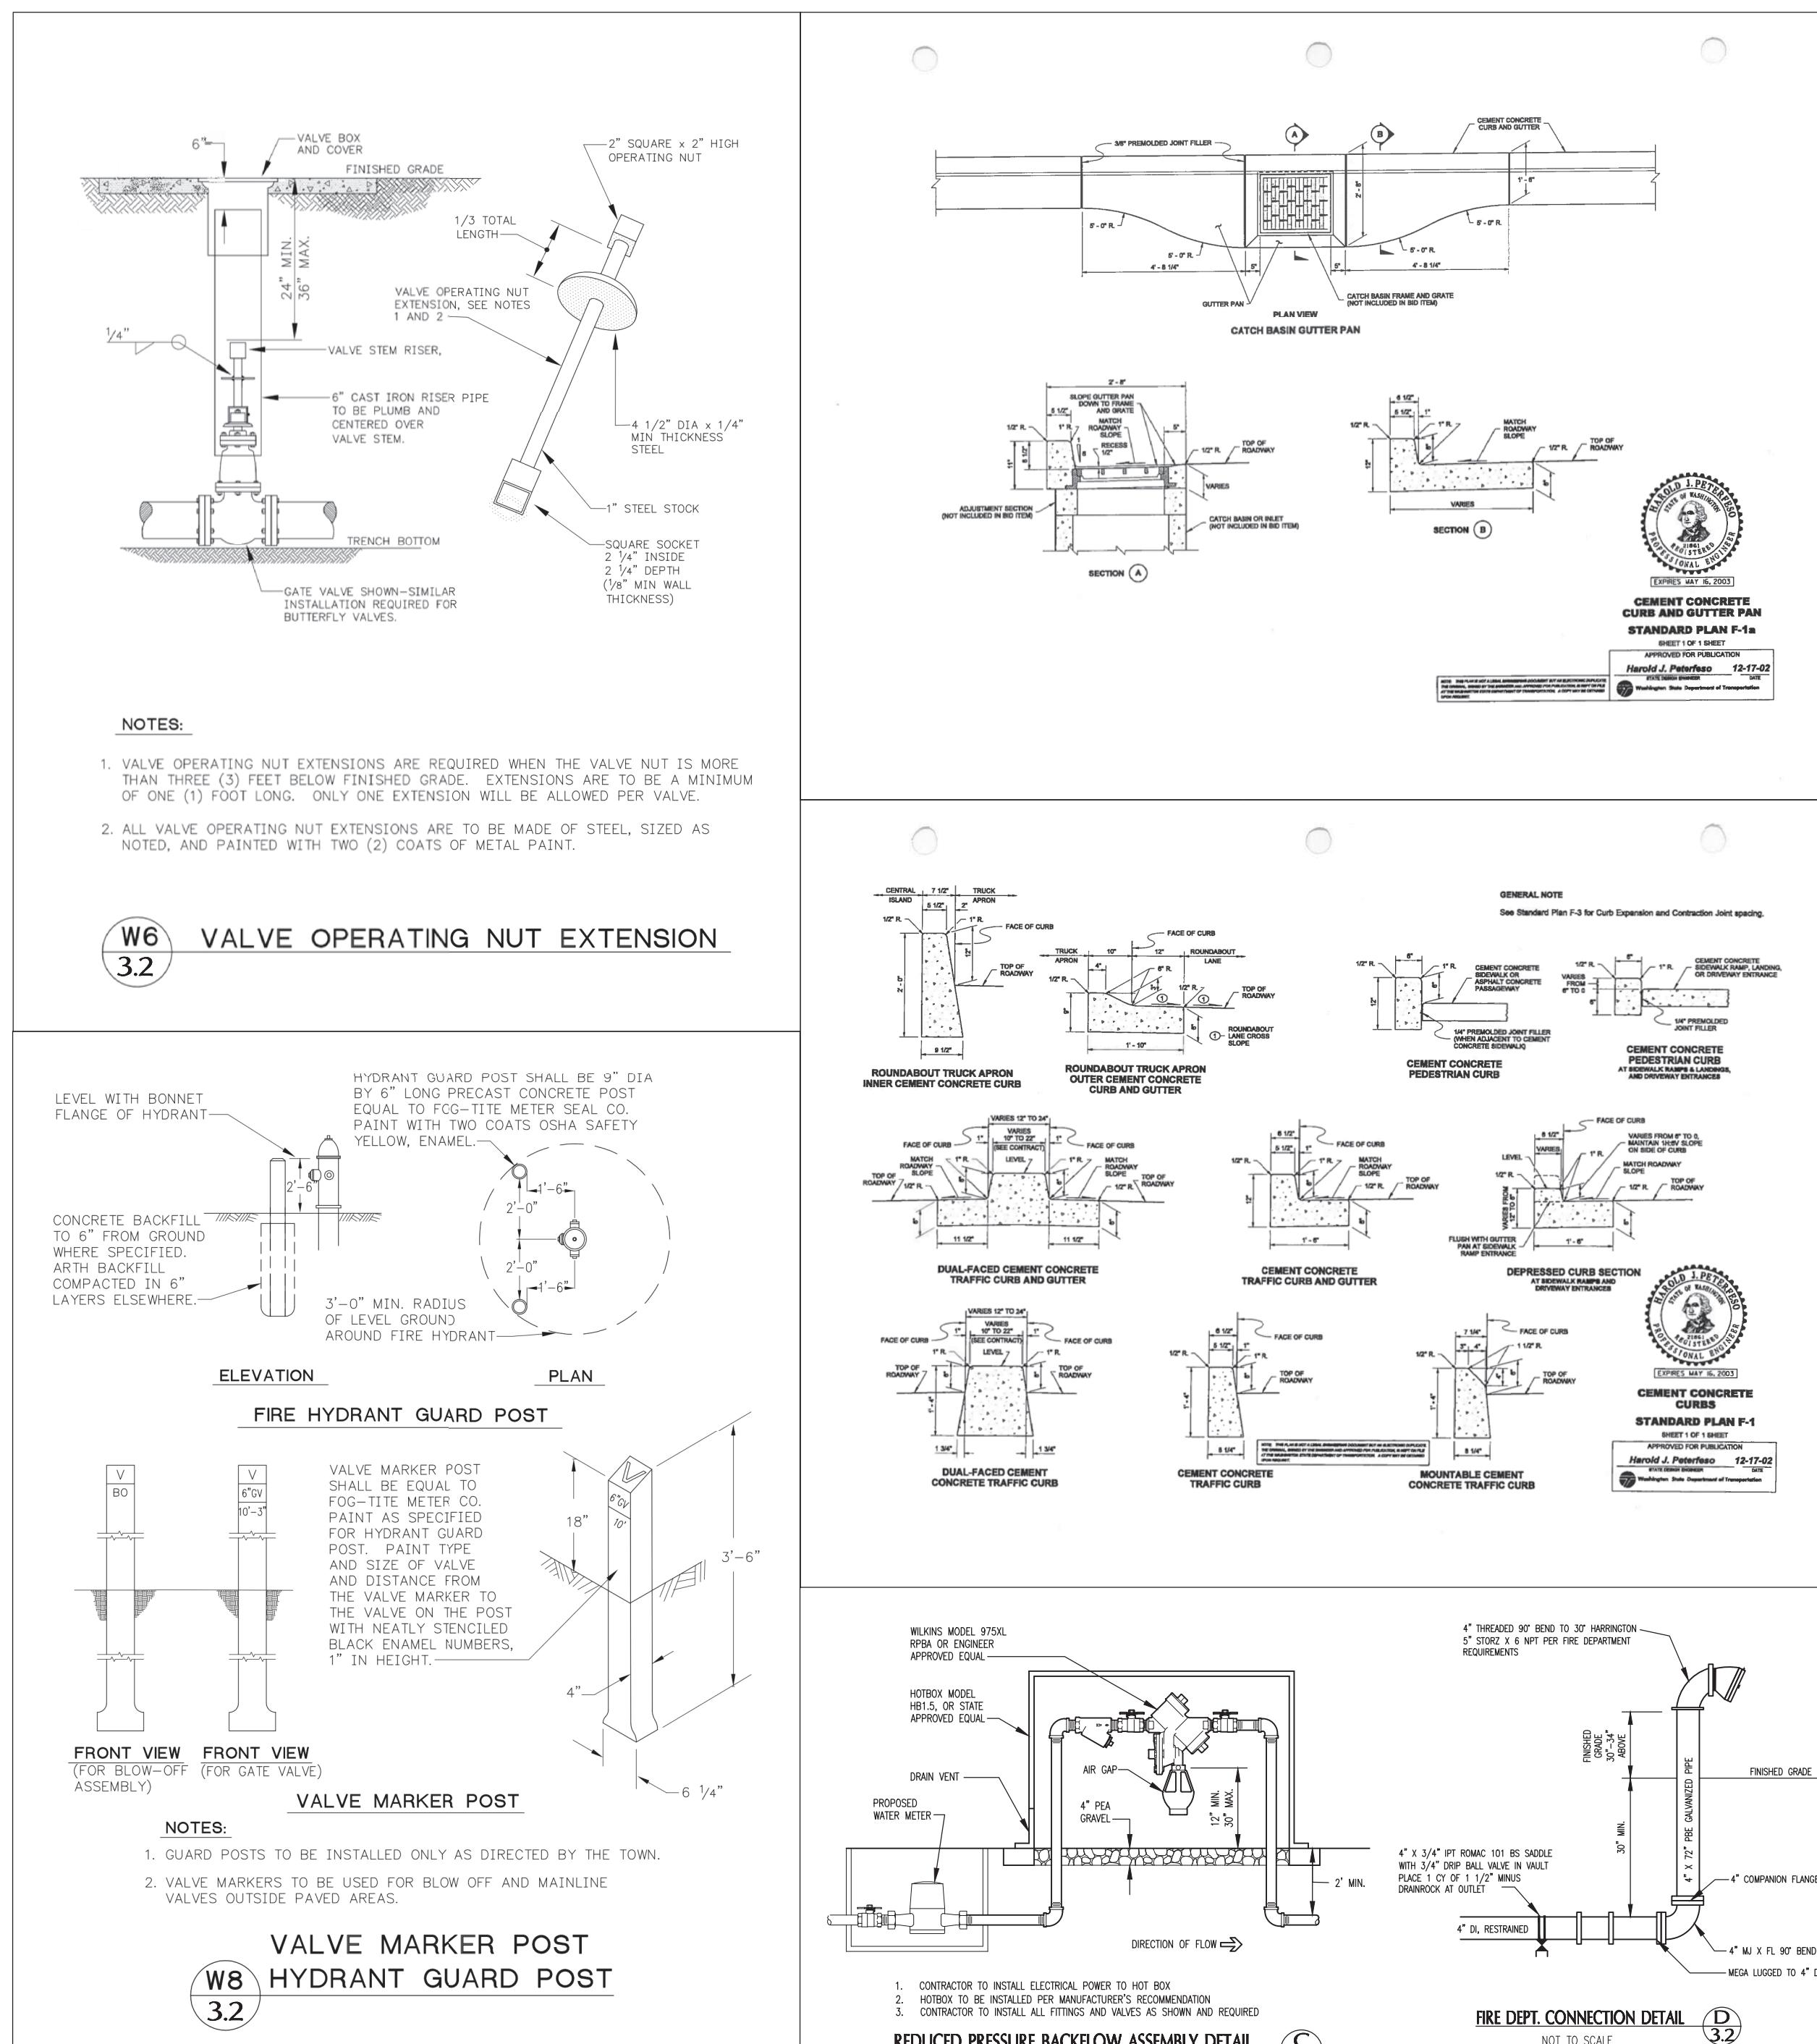

Sound Development Group
ENGINEERING, SURVEYING & LAND DEVELOPMENT SERVICES
P.O. Box 1705 • 1111 Cleveland Avenue, Suite 202
Mount Vernon, WA 98273 Tel: 360-404-2010

SHEET REVISIONS:
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1 9.22.23 ARCHITECT REVISION P.L.S.

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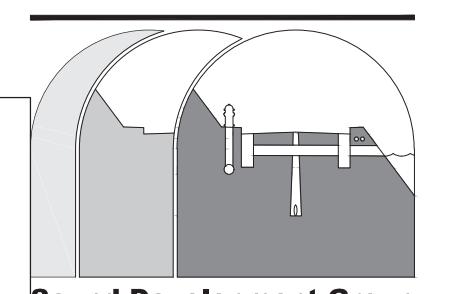
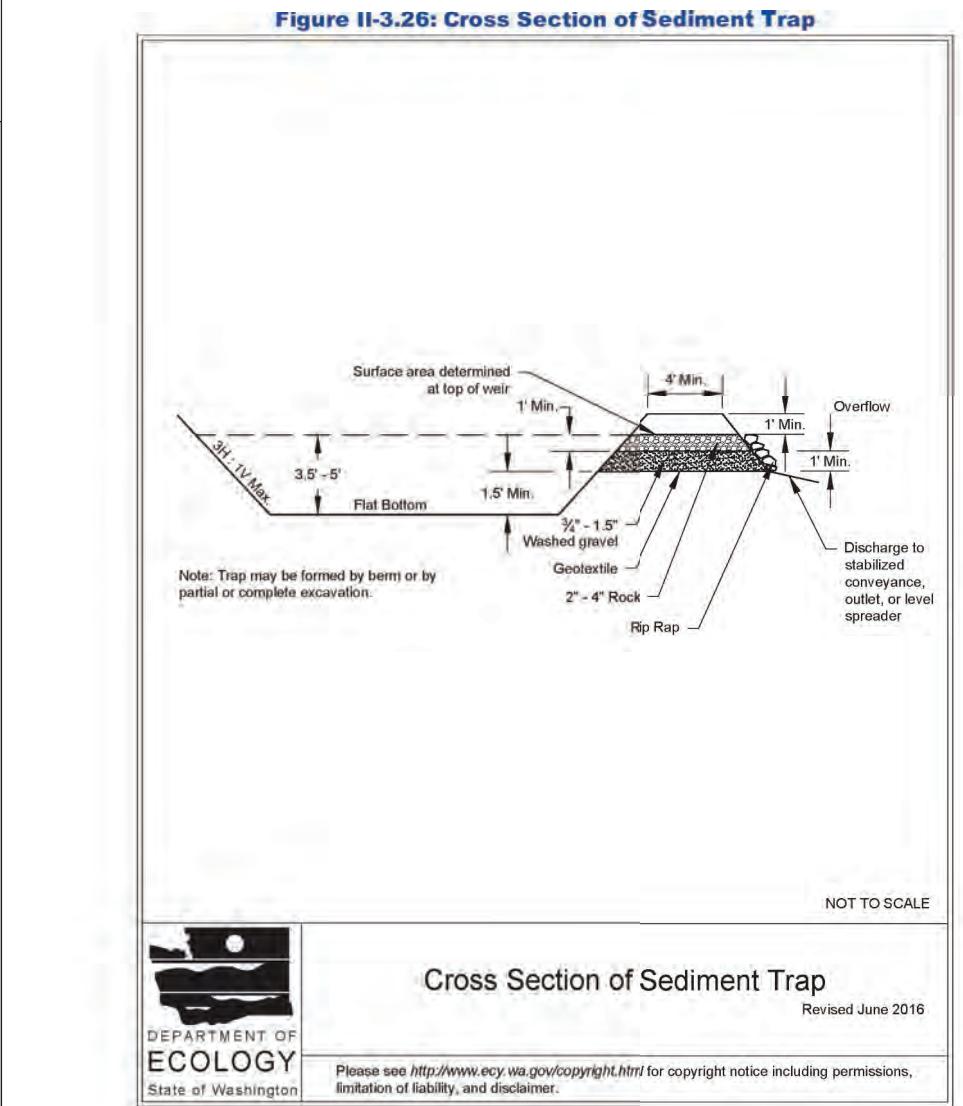
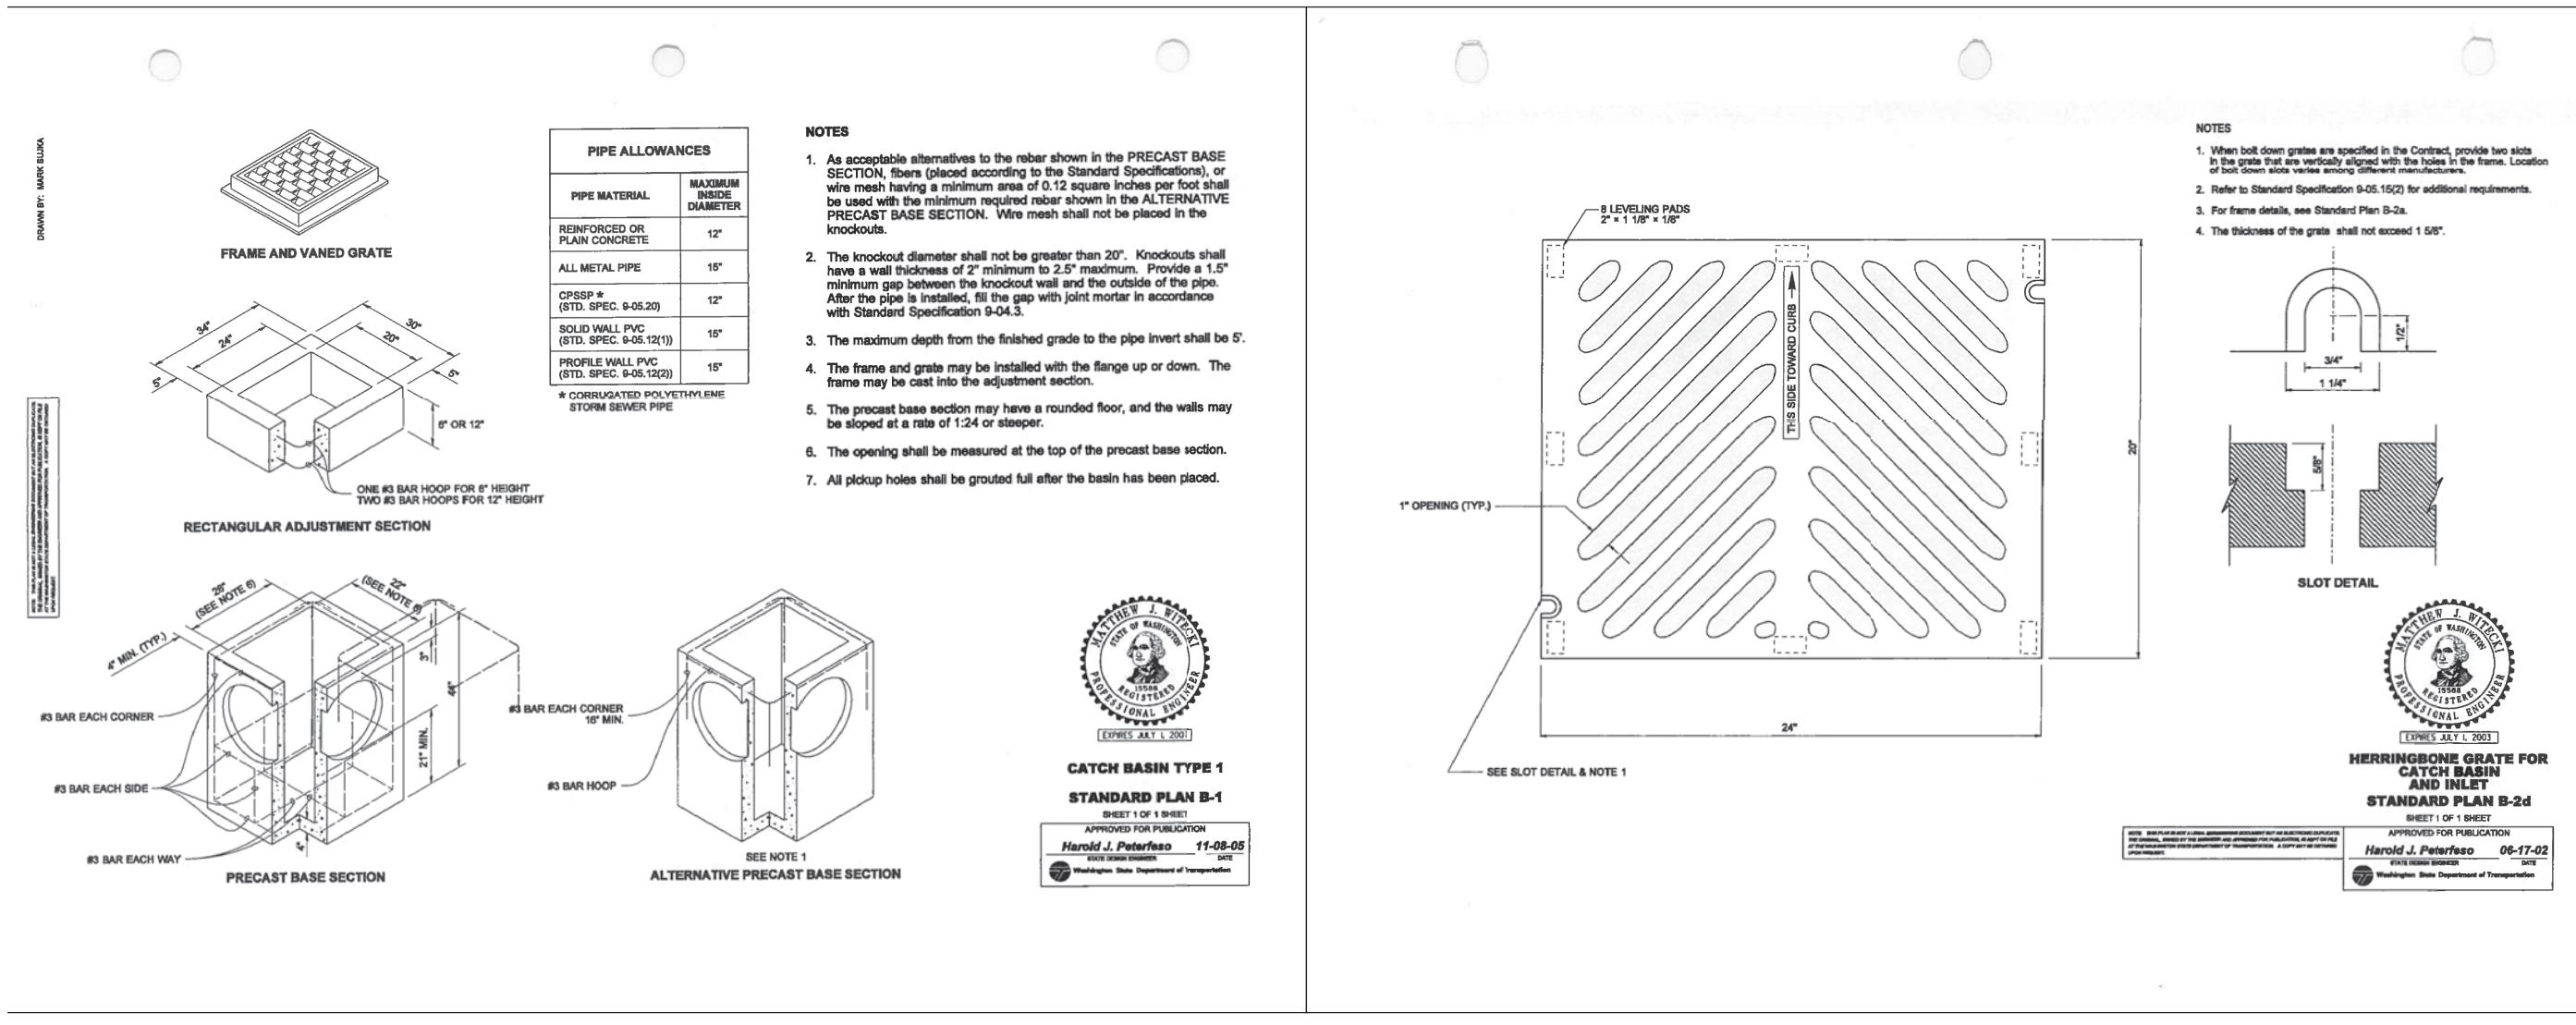
PROJECT:
**CENTER STREET
MIXED-USE**
FOR
KSA INVESTMENTS, LLC

SHEET DESCRIPTION:
**WATER, WSDOT
STANDARD PLANS &
CONSTRUCTION DETAILS**



SCALE: AS NOTED
DRAWN BY: C. SEVERIN
DESIGNED BY: P. SEVERIN
DATE: 08.30.2023
JOB NUMBER: 21098
DWG NAME: 21098PLN.DWG
SHEET NUMBER:

C3.2





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PROJECT:
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MIXED-USE
FOR
KSA INVESTMENTS, LLC



SHEET DESCRIPTION:

**WSDOT STANDARD PLANS
& SEDIMENT TRAP DETAIL**

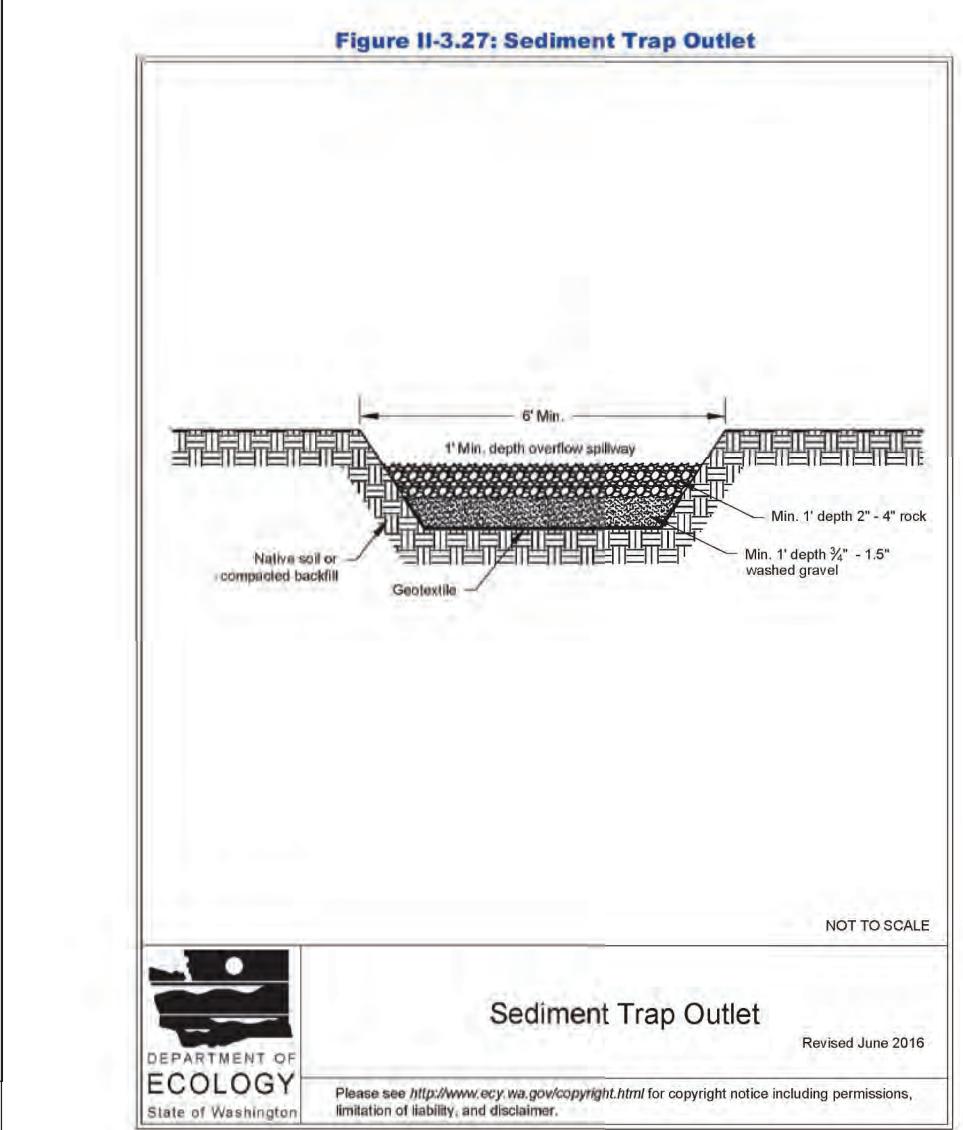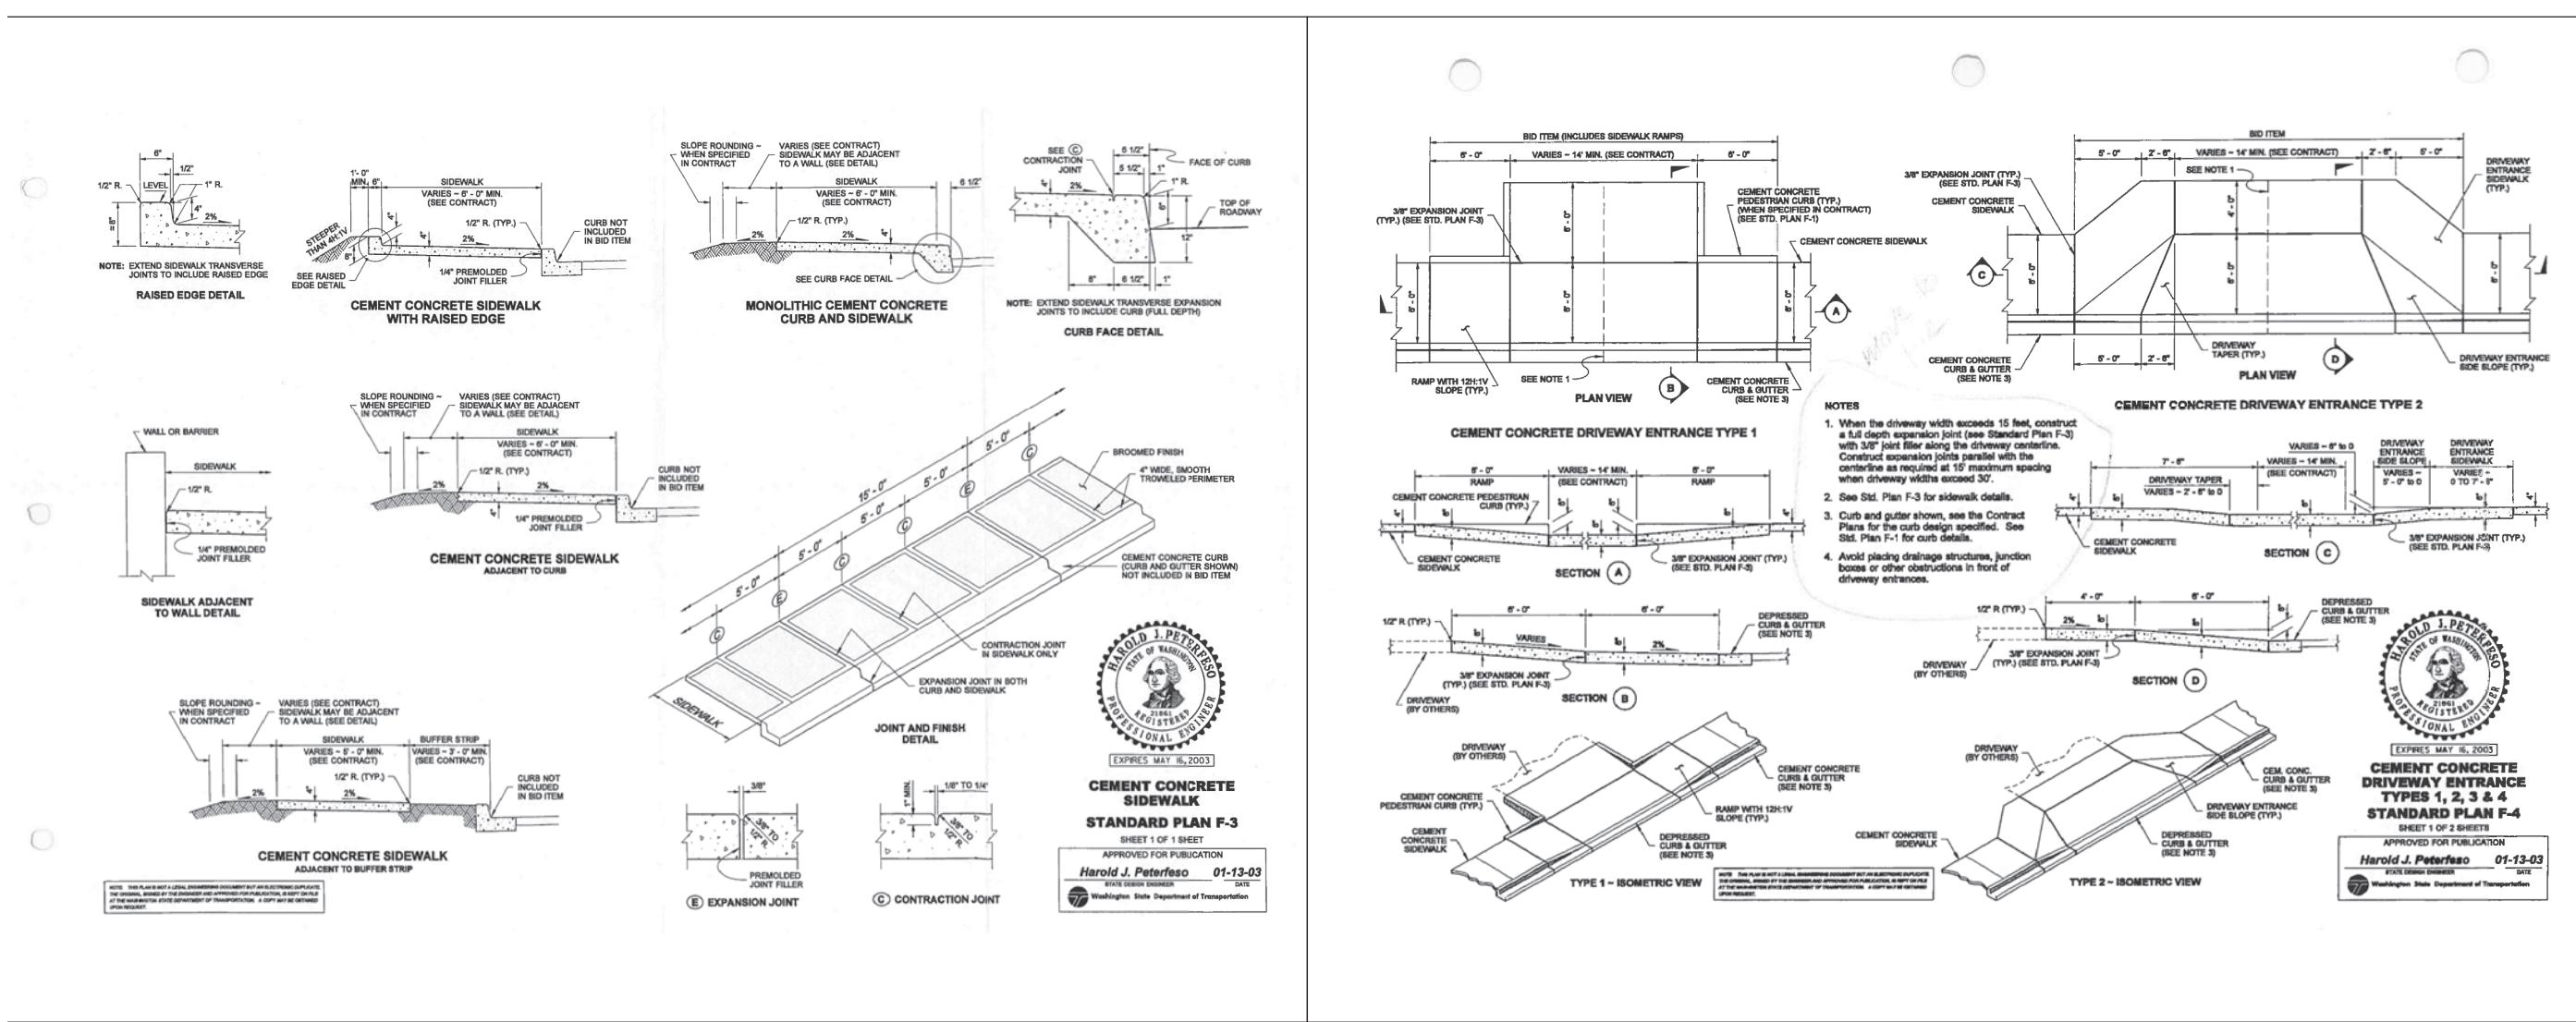

SCALE: AS NOTED
DRAWN BY: C. SEVERIN
DESIGNED BY: P. SEVERIN
DATE: 08.30.2023
JOB NUMBER: 21098
DWG NAME: 21098PLN.DWG
SHEET NUMBER:

C3.3

GENERAL CONSTRUCTION NOTES

1. ALL CONSTRUCTION AND MATERIALS SHALL CONFORM TO THE 2023 STANDARD SPECIFICATIONS FOR ROAD, BRIDGE, AND MUNICIPAL CONSTRUCTION AS PREPARED BY WASHINGTON STATE DEPARTMENT OF TRANSPORTATION AND THE AMERICAN PUBLIC WORKS ASSOCIATION (WSDOT/APWA), HEREIN REFERRED TO AS THE "STANDARD SPECIFICATIONS". REFERENCES WILL BE MADE TO THE STANDARD SPECIFICATIONS MANUAL AND THE STANDARD PLANS BOOK.

2. EXISTING UTILITIES HAVE BEEN TAKEN FROM AVAILABLE FIELD AND OFFICE RECORDS. THE CONTRACTOR IS RESPONSIBLE FOR UTILIZING THE ONE-CALL UTILITY LOCATE SERVICE, 1-800-245-5555, A MINIMUM OF TWO WORKING DAYS PRIOR TO ANY CONSTRUCTION DAMAGES TO THE EXISTING UTILITIES RESULTING FROM THIS CONSTRUCTION SHALL BE REPAIRED BY AND AT THE CONTRACTOR'S EXPENSE. THE CONTRACTOR SHALL VERIFY ANY POTENTIAL UTILITY CONFLICTS PRIOR TO CONSTRUCTION.

3. THE CONTRACTOR SHALL MAKE DAILY EFFORTS TO KEEP THE SITE IN A NEAT AND ORDERLY CONDITION TO THE SATISFACTION OF THE OWNER, ENGINEER, AND TOWN OF LA CONNER ENGINEERING DEPARTMENT. IF CONSTRUCTION OCCURS DURING RAINY WEATHER CONDITIONS, THEREBY CAUSING DEBRIS TO BE TRACKED ONTO THE EXISTING ASPHALT, THE CONTRACTOR SHALL CONSTRUCT A QUARRY SPALL ROADWAY 20'-FEET WIDE UP TO 100'-FEET LONG MINIMUM. THE CONTRACTOR IS RESPONSIBLE FOR DAMAGES TO EXISTING IMPROVEMENTS RESULTING FROM THIS CONSTRUCTION.

4. DURING ALL PHASES OF CONSTRUCTION, THE CONTRACTOR SHALL SHEEP AND REMOVE ALL DEBRIS TRACKED ONTO THE EXISTING ROADS. FAILURE TO KEEP ROAD FREE FROM DEBRIS OFF EXISTING ROADWAY MAY CAUSE WORK STOPPAGE. THE CONTRACTOR SHALL ALSO WATER THE SITE (IF REQUIRED) TO REDUCE CONSTRUCTION DUST.

5. AT ALL TIMES, TRAFFIC LANES SHALL BE MAINTAINED ON EXISTING ROADS. TEMPORARY AND PARTIAL ROAD CLOSURE SHALL BE APPROVED BY TOWN OF LA CONNER ENGINEERING, FIRE, AND POLICE DEPARTMENTS PRIOR TO CONSTRUCTION. DURING CONSTRUCTION WITHIN THE RIGHT-OF-WAYS, THE CONTRACTOR SHALL PROVIDE ALL LABOR, MATERIALS, AND EQUIPMENT FOR FIRE CONTROL AND CONSTRUCTION WARNING/CONTROL SIGNS.

6. THE CONTRACTOR SHALL COMPLY WITH ALL LOCAL, STATE, AND FEDERAL REGULATIONS CONCERNING DISPOSAL OF MATERIALS. ALL ASPHALT, CONCRETE, BRICK, AND STRUCTURES REMOVED FROM THIS SITE SHALL BE DISPOSED OF IN AN APPROVED SITE OBTAINED BY THE CONTRACTOR.

7. THE CONTRACTOR IS RESPONSIBLE FOR OBTAINING AND APPLYING FOR ALL PERMITS ASSOCIATED WITH THIS CONSTRUCTION NOT OBTAINED BY THE OWNER AND/OR ENGINEER.

8. THE ENGINEER SHALL BE IMMEDIATELY NOTIFIED PRIOR TO CONSTRUCTION IF ANY DISCREPANCY IN PLANS AND EXISTING CONDITIONS IS DISCOVERED.

9. THE CONTRACTOR SHALL STOCKPILE CLEAR NATIVE TOPSOIL MATERIALS, FREE OF SOIL AND DEBRIS, LARGER THAN TWO INCHES, TO USE IN THE REPAIR OF EXISTING ROADWAYS AREAS. THE CONTRACTOR SHALL STOCKPILE EXCESS NATIVE MATERIAL FROM SITE AS DIRECTED BY THE OWNER. EXCESS AND UNSUITABLE NATIVE MATERIAL SHALL BE COMPACTED BY THE CONTRACTOR AT AN APPROVED DISPOSAL SITE RETAINED BY THE CONTRACTOR.

10. ALL PORTIONS OF THE SITE UNDER THE PROPOSED ASPHALT SHALL BE EXCAVATED TO EXPOSE A NON-ORGANIC MATERIAL SUITABLE FOR CONSTRUCTION. THE SUBGRADE SHALL BE PREPARED CONFORMING TO SECTION 2-04.301, AND COMPACTED TO A MINIMUM OF 105% MAXIMUM DENSITY WITH A MINIMUM TEN-TON SELF-PROPELLED VIBRATORY ROLLER. ANY AREAS THAT INDICATE PUMPING, UNSTABLE, OR YIELDING SOIL CONDITIONS SHALL BE OVER EXCAVATED AND REPLACED WITH TWO INCHES OF CLEAN, DRY, NATIVE SOIL. STOCKPILED MATERIAL SHALL BE OVERLAIN WITH PROTECTION FROM OVER-SATURATION BY RAINFALL OR PONDED WATER. FINAL GRADED CONDITIONS SHALL BE RADED TO REMOVE ALL DEBRIS LARGER THAN ONE-INCH FROM THE SURFACE.

11. ORGANIC MATERIAL AND NON-SUITABLE NATIVE MATERIAL DISCOVERED DURING SUBGRADE EXCAVATION AND SITE PREPARATION SHALL ENTIRELY REMOVED AND DISPOSED OF BY THE CONTRACTOR AT THE CONTRACTOR'S EXPENSE.

12. DURING PERIODS OF RAINFALL, THE CONTRACTOR SHALL PREVENT WATER FROM STANDING ON THE SUBGRADE OR ON THE PREPARED GRAVEL SUBGRADE. THE CONTRACTOR SHALL PROVIDE A PERMANENT DRAINAGE SYSTEM TO REMOVE AND RELOCATE THE EXCESS SOIL MATERIAL. THIS BEARING SHOULDN'T BE PAID FOR AT THE CONTRACTOR'S EXPENSE. THE RUNOFF SHALL BE DISCHARGED TO THE STORM SYSTEM OR ON-SITE LOCATION THAT WILL NOT IMPACT THE NEIGHBORING PROPERTIES. THIS PROJECT, DOWNSTREAM CONVEYANCE SYSTEM. THE CONTRACTOR IS REQUIRED TO PROVIDE TEMPORARY DITCHING AND PUMP TO REMOVE ALL STANDING WATER FROM THE WORK AREA.

13. STRUCTURAL FILL TO FILL IN THE SWALE IS TO BE GLACIAL TILL, OR AS PROVIDED BY THE PROJECT GEOTECHNICAL ENGINEER. STRUCTURAL FILL FOR DRY WEATHER CONSTRUCTION MAY CONTAIN UP TO 10 PERCENT FINE (THAT PORTION PASSING THE U.S. NO. 200 SIEVE) BASED ON THE PORTION PASSING THE U.S. NO. 4 SIEVE. IMPORTED HAVING MORE THAN 10% FINE MATERIAL IS NOT RECOMMENDED. THE DEEMED FINE MATERIAL IS TO BE REMOVED AND RELOCATED. STRUCTURAL FILL FOR WET WEATHER CONSTRUCTION IS TO BE GLACIAL TILL, OR LESS THAN 5% FINE MATERIAL. THE OWNER SHALL PROVIDE INITIAL GRADATION AND TEST RESULTS TO THE ENGINEER FOR APPROVAL. GRADATION AND PROCTOR TEST RESULTS SHALL BE PROVIDED BY THE OWNER PER 2000 TONS OF IMPORTED MATERIAL. CRITERIA FOR COMPACTED TILL LINERS IS GIVEN IN SECTION V-1.3 OF THE STORMWATER MANAGEMENT MANUAL FOR WESTERN WASHINGTON. REFER TO THE GEOTECHNICAL REPORT FOR ADDITIONAL INFORMATION ON STRUCTURAL FILL SPECIFICATIONS.

14. GRAVEL BORROW (IMPORTED STRUCTURAL FILL) SHALL COMPLY WITH SECTION 9-03.14(1) OF THE 2023 STANDARD SPECIFICATIONS OR THE IMPORTED STRUCTURAL FILL REQUIREMENTS OUTLINED IN THE GEOTECHNICAL REPORT. WHICHEVER IS MORE RESTRICTIVE. GRAVEL BASE SHALL CONSIST OF WELL-GRADED SAND AND GRAVEL CONFORMING TO THE REQUIREMENTS OF THE CONTRACTOR. THE PERMEABILITY TEST FOR THE DENSEST FRACTION OF THE IMPORTED STRUCTURAL FILL FOR WET WEATHER CONSTRUCTION IS TO BE 100% PASS. THE OWNER SHALL PROVIDE INITIAL GRADATION AND TEST RESULTS TO THE ENGINEER FOR APPROVAL. GRADATION AND PROCTOR TEST RESULTS SHALL BE PROVIDED BY THE CONTRACTOR PER 2000 TONS OF IMPORTED MATERIAL. THE CONTRACTOR SHALL RETAIN LICENSED PERSONNEL TO PERFORM COMPACTION TESTS FOR THE FOLLOWING:

A. TOP OF PREPARED GRAVEL BORROW WITHIN THE PARKING LOT AND ROAD SECTION ON A 50-FOOT GRIDINTERVAL FOR GRAVEL FILLS GREATER THAN TWO FEET.

B. ONE TEST ADJACENT TO ALL STRUCTURES WITHIN THE ASPHALT.

C. TRENCHES WITH THREE FEET OR LESS OF GRAVEL TRENCH BACKFILL; TOP CENTER OF UTILITY TRENCH AT 50-FOOT INTERVALS.

D. TRENCHES WITH MORE THAN THREE FEET OF GRAVEL TRENCH BACKFILL; TOP CENTER OF UTILITY TRENCH AND MID-DEPTH OF TRENCH, BOTH AT 50-FOOT INTERVALS. ALL TEST RESULTS SHALL MEET OR EXCEED THE SPECIFICATIONS.

ALL AREAS THAT DO NOT MEET THE REQUIRED SPECIFICATIONS SHALL BE RE-COMPACTED AND RETESTED AT NO ADDITIONAL COST TO THE OWNER.

15. CRUSHED SURFACING TOP COURSE SHALL CONFORM TO SECTION 5-04 OF THE 2023 STANDARD SPECIFICATIONS. THE FINAL GRADING OF CRUSHED SURFACING THAT IS TO BE COMPACTED SHALL BE PRESSED/COMPACTED PRIOR TO PLACEMENT. THE CONTRACTOR SHALL ENSURE THAT THE CRUSHED SURFACING IS CUT FULL DEPTH TO PROVIDE A NEAT STABLE EDGE FOR THE NEW ASPHALT. ALL CUT FACE SHALL BE TACK COATED AS WELL AS ALL STRUCTURES THAT ABUT ASPHALT. THE SURFACE JOINT BETWEEN EXISTING AND NEW ASPHALT MUST BE SEALED WITH HEAT-APPLIED CSS-1 AND SAND COAT. ASPHALT SURFACE THAT HAS LOOSE MATERIAL OR POROUS CONDITIONS AS DETERMINED BY THE ENGINEER SHALL BE CRUSHED ACCORDING TO SECTION 5-04.35(C) CRACK SEALING, AT NO ADDITIONAL COST TO THE OWNER. WITHIN THE CRUSHED SURFACE, THE CONTRACTOR SHALL ENSURE THAT THE CRUSHED SURFACE IS PLACED WITHIN THE PARKING LOTS AND ROADS.

16. HOT MIX ASPHALT SHALL BE PLACED AT THE LOCATIONS AND DEPTHS INDICATED ON THE PLANS. HOT MIX ASPHALT SHALL BE MECHANICALLY COMPACTED TO A MINIMUM OF 105% DENSITY AS DETERMINED BY ASTM D-1571 TESTING PROCEDURE. PLACEMENT AND GRADING OF COMPACTED CRUSHED COURSE MATERIAL WITHIN THE ASPHALT AREAS SHALL HAVE A TOLERANCE OF PLUS OR MINUS ONE-HALF INCH FROM THE DESIGNATED TOP OF CRUSHED SURFACING TOP COURSE. THE OWNER SHALL PROVIDE GRADATION AND DEGRADATION TEST RESULTS TO THE ENGINEER FOR APPROVAL OF THE MATERIAL.

17. ASPHALT CONCRETE PAVEMENT SHALL CONFORM TO SECTION 5-04 OF THE 2023 STANDARD SPECIFICATIONS. THE FINAL GRADING OF CRUSHED SURFACING THAT IS TO BE COMPACTED SHALL BE PRESSED/COMPACTED PRIOR TO PLACEMENT. THE CONTRACTOR SHALL ENSURE THAT THE CRUSHED SURFACING IS CUT FULL DEPTH TO PROVIDE A NEAT STABLE EDGE FOR THE NEW ASPHALT. ALL CUT FACE SHALL BE TACK COATED AS WELL AS ALL STRUCTURES THAT ABUT ASPHALT. THE SURFACE JOINT BETWEEN EXISTING AND NEW ASPHALT MUST BE SEALED WITH HEAT-APPLIED CSS-1 AND SAND COAT. ASPHALT SURFACE THAT HAS LOOSE MATERIAL OR POROUS CONDITIONS AS DETERMINED BY THE ENGINEER SHALL BE CRUSHED ACCORDING TO SECTION 5-04.35(C) CRACK SEALING, AT NO ADDITIONAL COST TO THE OWNER. WITHIN THE CRUSHED SURFACE, THE CONTRACTOR SHALL ENSURE THAT THE CRUSHED SURFACE IS PLACED WITHIN THE PARKING LOTS AND ROADS.

18. CONCRETE SIDEWALKS SHALL BE INSTALLED AS INDICATED ON THE CIVIL PLANS. SIDEWALKS SHALL BE SIX INCHES THICK SUPPORTED BY A MINIMUM OF SIX-INCHES OF GRAVEL BORROW COMPACTED TO A MINIMUM OF 95% DENSITY AS DETERMINED BY THE CONTRACTOR. SIDEWALKS LESS THAN SIX-INCHES THICK SHALL BE SUPPORTED BY A PROPOSED CONCRETE WALL WITH ONE-INCH SCORED JOINTS INSTALLED AT FIVE FEET ON CENTER. EXTRUDED CURB SHALL BE PLACED ON FINISHED CONCRETE SURFACE AND BONDED WITH CONCRETE EPOXY OR CONCRETE SLURRY. CURBS SHALL BE PLACED IN STRAIGHT LINES AND NOT TURNED. EXTRUDED CURB SHALL BE PLACED ON THE SIDEWALKS AND NOT ON THE PAVEMENT. JOINTS BEYOND THE BACK OF EXTRUDED CONCRETE CURB SHALL BE SAW CUT FULL DEPTH AND REMOVED. ALL CONCRETE PAVEMENT, UNLESS OTHERWISE SPECIFIED, IS TO HAVE 1.5-INCH CRACK JOINTS SPACED AT 12 FEET MAXIMUM INTERVALS IN BOTH DIRECTIONS AND ARE TO BE SEALED TO RESTRICT WATER INFILTRATION INTO THE JOINTS.

STORM SEWER

1. THE FOLLOWING MATERIALS ARE ACCEPTABLE FOR THE STORM SEWERS IDENTIFIED ON THE PLANS:

A. PVC PIPE (POLYVINYL CHLORIDE) OVER 8" IN DIAMETER SHALL CONFORM TO SECTION 9-05.12(2) MEETING THE REQUIREMENTS OF ASTM C1303 SDRS. PVC 8" IN DIAMETER AND UNDER SHALL CONFORM TO SECTION 9-05.15 OF THE STANDARD SPECIFICATIONS MEETING THE REQUIREMENTS OF AASHTO M24 TYPE 5.

B. CORRUGATED POLYETHYLENE PIPE (CPP) SHALL HAVE A SMOOTH BARREL, EXTERIOR, CORRUGATED EXTERIOR, CONFORMING TO SECTION 9-05.17(1) MEETING THE REQUIREMENTS OF AASHTO M24.

C. PROFILE WALL PVC STORM PIPE 15" AND UNDER SHALL CONFORM TO SECTION 9-05.12(2) OF THE STANDARD SPECIFICATIONS MEETING THE REQUIREMENTS OF AASHTO M30 SDRS. ALL FITTINGS SHALL CONFORM TO ASTM F794. ALL PIPES SHALL HAVE GASKETED JOINTS.

2. STORM CATCH BASINS AS INDICATED ON THE PLANS SHALL CONFORM TO TOWN OF LA CONNER ENGINEERING DEPARTMENT AND:

TYPE 1 CATCH BASIN PER CUZ CONCRETE CB DETAIL
TYPE 1L CATCH BASIN PER WSDOT STD. PLAN B-20-01
CATCH BASIN STD. GRATE PER WSDOT STD. PLAN B-30-01
CATCH BASIN THRU CURB GRATE PER WSDOT STD. PLAN B-25-01
ALL CATCH BASINS SHALL HAVE A MINIMUM 2-FOOT TUMBLE UNLESS OTHERWISE INDICATED.

IF SUBGRADE CONDITIONS ARE SOFT BELOW PROPOSED STRUCTURES, THE FOUNDATION SHALL BE OVER-EXCAVATED TWO FEET, AND THREE FEET FROM THE SIDES OF THE STRUCTURE, AND BACK-FILLED WITH MECHANICALLY COMPACTED 2-FOOT QUARRY SPALLS. ALL STRUCTURE JOINTS MUST BE GASKETED.

3. ALL PVC PIPE CONNECTIONS SHALL BE MADE TO STRUCTURES USING PVC SADDLE COLLARS.

4. UPON INSTALLATION OF ALL PIPES TO STORM STRUCTURES, THE KNOCKOUT AREA SHALL BE NEATLY MUDDED INSIDE AND OUT OF THE CATCH BASIN USING A NON-SHRINK CONCRETE CROUT.

5. UPON COMPLETION OF ALL CRUSHES TOP COURSE GRADING AND PREPARATION FOR ASPHALT PAVING, ALL CATCH BASIN STRUCTURES SHALL BE CORRECTLY ADJUSTED AS TO THE PROPOSED FINISH GRADE.

6. UPON PROJECT COMPLETION, THE CONTRACTOR SHALL FLUSH ALL STORM PIPES TO REMOVE ANY DEBRIS. DEBRIS SHALL NOT BE DISPOSED OF INTO THE DOWNSTREAM DRAINAGE SYSTEM, BUT DISPOSED IN AN APPROPRIATE MANNER.

7. BLACK LETTERING SHALL BE EMBOSSED ON THE TOP SURFACES OF GRATES AND COVERS AS FOLLOWS:

A. "DRAIN" - 3-INCH LETTERS ON ALL SOLID COVERS.

B. "OUTLET TO STREAM DUMP NO POLLUTANTS" - 1/8-INCH LETTERS ON ALL GRATES.

8. ALL SOLID COVERS AND GRATES SHALL BE SECURED WITH 5/8-INCH STAINLESS STEEL SOCKET HEAD CAP SCREWS.

A LIGHT COATING OF ANTI-SEIZE THREAD COMPOUND SHALL BE APPLIED TO THE SCREWS AT THE TIME OF INSTALLATION. THE ANTI-SEIZE COMPOUND USED SHALL BE LOCITE 767 OR APPROVAL EQUAL. ANTI-SEIZE COMPOUND SHALL BE APPLIED ACCORDING TO THE MANUFACTURER'S RECOMMENDATIONS.

OTHER LOCKING DEVICES ARE ACCEPTABLE SUBJECT TO APPROVAL BY TOWN OF LA CONNER ENGINEERING DIRECTOR.

SANITARY SEWER

2. THE LOCATION OF THE SANITARY SEWER SERVICE IS INDICATED ON THE PLANS. SEWER SERVICE SHALL BE INSTALLED AT THE LOCATION AND ELEVATION AS INDICATED ON THE CIVIL PLANS.

3. SEWER PIPE SHALL BE PVC, CONFORMING TO ASTM D3034, SDRS 35 AND SECTION 9-05.10 OF THE 2023 STANDARD SPECIFICATIONS. JOINTS INDICATE PUMPING, UNSTABLE, OR YIELDING SOIL CONDITIONS SHALL BE OVER EXCAVATED AND REPLACED WITH PROTECTION FROM OVER-SATURATION BY RAINFALL OR PONDED WATER. FINAL GRADED CONDITIONS SHALL BE RADED TO REMOVE ALL DEBRIS LARGER THAN ONE-INCH FROM THE SURFACE.

4. CLEANOUTS SHALL BE INSTALLED AT LOCATIONS AND ELEVATIONS AS SHOWN ON THE CONSTRUCTION PLANS. CLEANOUTS SHALL CONFORM TO THE CONSTRUCTION DETAIL, AND THE TOWN OF LA CONNER REQUIREMENTS. CLEANOUTS SHALL BE INSTALLED TO MATCH FINISH GRADE WITHIN CONCRETE AND ASPHALT AREAS.

5. THE CONTRACTOR IS TO INSTALL ALL COMPONENTS OF THE SANITARY SEWER SYSTEM A TO PREVENT ANY INTRUSION ON EXISTING GROUNDRIDES.

6. AIR PRESSURE TESTING, IF REQUIRED BY THE TOWN OF LA CONNER PUBLIC WORKS, SHALL BE PERFORMED BY THE CONTRACTOR ON ALL PROPOSED SEWER LINES. THE PRESSURE TEST SHALL BE PERFORMED AT FIVE PSI FOR TEN MINUTES WITH NO SIGNIFICANT GAUGE DROP. ADEQUATE TIME (TWO MINUTES MINIMUM) SHALL ELAPSE BEFORE THE PRESSURE TEST IS PERFORMED TO ALLOW THE PRESSURE TO STABILIZE. THE CONTRACTOR IS RESPONSIBLE FOR RETAINING ALL STRUCTURES, CLEANOUTS AND PIPE ENDS DURING THIS TEST.

UTILITY TRENCHES

1. ALL TRENCHES SHALL BE EXCAVATED TO PROVIDE A MINIMUM WIDTH OF EIGHT INCHES ON EITHER SIDE OF THE PROPOSED UTILITY AND A VIBRATED CONCRETE UTILITY TRENCH DETAIL WITHIN THE CIVIL DRAWINGS. ALL STORM AND SEWER PIPES SHALL BE BEDDED WITH GRAVEL OR RUCKSHOT WITH 100% OF THE MATERIAL PASSING THE 1/4-INCH SCREEN BEDDING MATERIAL SHALL ALSO BE USED TO COVER THE PIPE TO A MINIMUM OF FOUR INCHES ABOVE THE TOP OF THE PIPE. THE CONTRACTOR SHALL CORRECTLY TAMP AND HAND COMPACT BEDDING AND COVER MATERIAL TO ASSURE ADEQUATE SUPPORT UNDER THE BARREL OF THE PIPE.

2. TRENCH BACKFILL MATERIAL SHALL CONSIST OF COMPACTED GRAVEL BORROW PLACED IN LOOSE LIFTS NOT EXCEEDING EIGHT INCHES AND COMPACTED TO A MINIMUM OF 105% MAXIMUM DENSITY AS DETERMINED AS ASTM D-1571 TESTING PROCEDURE. THE INITIAL LIFT OF GROUTED TRENCH BACKFILL OVER THE PIPE SHALL NOT EXCEED 18 INCHES IN ORDER TO PROTECT THE PIPE. STONE BACKFILL SHALL BE USED AS TRENCH BACKFILL IN ALL TRENCHES UNDER PROPOSED ASPHALT, CONCRETE, CONSTRUCTION TRAFFIC AREAS, AND WITHIN FIVE FEET BEYOND IMPERVIOUS SURFACES. NATIVE MATERIAL SHALL NOT BE USED AS TRENCH BACKFILL.

3. GRAVEL BACKFILL MATERIAL MAY BE USED AS TRENCH BACKFILL, ONLY AT LOCATIONS BEYOND THOSE REQUIRING GRAVEL. STRUCTURAL FILL, THE USE OF NATIVE SOIL MATERIALS AS TRENCH BACKFILL, WITHIN THOSE AREAS REQUIRING GRAVEL SHALL BE APPROVED BY THE GEOTECHNICAL ENGINEER, TOWN OF A CONNER AND OWNER PRIOR TO THE WORK BEING PERFORMED. THE USE OF NATIVE SOILS WITHIN TRENCHES REQUIRING GRAVEL WILL ONLY BE ACCEPTED WITH THE APPROVAL OF THE GEOTECHNICAL ENGINEER. THE NATIVE SOILS MUST BE COMPACTED TO A MINIMUM OF 105% MAXIMUM DRY DENSITY. THE USE OF NATIVE SOILS AS TRENCH BACKFILL SHALL NOT PRECLUDE THE MINIMUM ASPHALT SECTION REQUIREMENTS AS IDENTIFIED ON THE CIVIL PLANS.

4. AT LOCATIONS WHERE NATIVE SOILS ARE USED, RESULTING IN PUMPING, UNSTABLE TRENCH CONDITIONS, OR THE SOILS USED CONTAIN UNSUITABLE PRODUCTS, THE CONTRACTOR SHALL REMOVE ALL UNSUITABLE MATERIALS AND REPLACE WITH APPROPRIATE NATIVE MATERIAL OR IMPORTED GRAVEL STRUCTURAL FILL MATERIAL AT THE CONTRACTOR'S EXPENSE.

5. THE BOTTOM OF UTILITY TRENCHES SHALL HAVE A STABLE, NON-YIELDING, SOIL CONDITION SUITABLE FOR SUPPORTING THE TRENCH. SOILS WITHIN TRENCHES REQUIRING GRAVEL MUST EXHIBIT PUMPING CONDITIONS. THE BOTTOM OF TRENCH SHALL BE OVER EXCAVATED TO EXPOSE FIRM, STABLE MATERIAL, AND BACKFILL WITH TWO INCH TO FOUR INCH SHOT ROCK MATERIAL, WHERE OVER EXCAVATING EXPOSES SIMILAR INSTABBLE CONDITIONS. TRENCH OVER EXCAVATION SHALL BE DONE TO TWO FEET BELOW THE PIPE BEDDING MATERIAL AND BACKFILLED WITH TWO INCH TO FOUR INCH SHOT ROCK MATERIAL.

6. THE CONTRACTOR SHALL PROVIDE AND COORDINATE WITH PGUT SOUND ENERGY, VERIZON NORTHEAST, COMCAST CABLE SERVICES AND CASCADE NATURAL GAS FOR THE UNDERGROUND INSTALLATION OF POWER, TELEPHONE, UTILITIES AND VAULT TRENCHING AND BACKFILLING AS REQUIRED AND DELINEATED ON UTILITY PLANS TO PROVIDE SERVICE TO LOTS SHOWN HEREIN, UNLESS SPECIFICALLY IDENTIFIED OTHERWISE ON THE PLANS. ALL NONMETALLIC UTILITY CONDUITS SHALL HAVE DETECTABLE MARKING TAPE CONFORMING TO WSDOT SECTION 9-15.15 INSTALLED DURING CONDUIT PLACEMENT.

7. PVA GRAVEL SHALL NOT BE USED WITHIN ANY PORTION OF THE WATER SYSTEM.

8. THE OWNER SHALL RETAIN LICENSED AND QUALIFIED PERSONNEL TO PROVIDE COMPACTION TESTING FOR THE FOLLOWING:

A. TRENCHES WITH THREE FEET OR LESS OF GRAVEL TRENCH BACKFILL; TOP CENTER OF UTILITY TRENCH AT 50-FOOT GRIDINTERVALS.

B. TRENCHES WITH MORE THAN THREE FEET OF GRAVEL TRENCH BACKFILL; TOP CENTER OF UTILITY TRENCH AND MID-DEPTH OF TRENCH, BOTH AT 50-FOOT INTERVALS. ALL TEST RESULTS SHALL MEET OR EXCEED THE SPECIFICATIONS.

ALL AREAS THAT DO NOT MEET THE REQUIRED SPECIFICATIONS SHALL BE RE-COMPACTED AND RETESTED AT NO ADDITIONAL COST TO THE OWNER.

9. AS COMPACTION TESTS ARE PERFORMED, THE OWNER IS RESPONSIBLE FOR PROVIDING FOR ALL COMPACTION TESTING RECORDS TO THE CONTRACTOR, ENGINEER AND TOWN OF LA CONNER ENGINEERING DEPARTMENT.

10. ALL TRENCH EXCAVATION OVER A DEPTH OF 4 FEET SHALL BE SHORED AND CRIBBED IN ACCORDANCE WITH THE REQUIREMENTS OF THE WASHINGTON INDUSTRIAL SAFETY AND HEALTH ACT, CHAPTER 49.17 ROW, AND IN ACCORDANCE WITH SECTION 2.09 OF THE STANDARD SPECIFICATIONS.



11. IF GROUND WATER IS ENCOUNTERED, TRENCH DRAINS SHALL BE INSTALLED IN TRENCHES WITH GROUND WATER CONDITIONS. DRAINS SHALL GRAVITY DRAIN TO DAYLIGHT OR THE NEAREST CATCH BASIN. PERFORATED PIPE OPENINGS SHALL BE SIZED TO NOT ALLOW BEDDING MATERIAL INTO DRAIN PIPE.

CONFLICT NOTE

ALL CONSTRUCTION IN TOWN OF LA CONNER RIGHT OF WAY SHALL BE IN COMPLIANCE WITH THE TOWN OF LA CONNER CONSTRUCTION STANDARDS. IN THE EVENT THAT THERE IS A CONFLICT BETWEEN THE PROJECT PLANS AND SPECIFICATIONS, THE TOWN OF LA CONNER CONSTRUCTION STANDARDS NOTES SHALL BE USED.

TOWN OF LA CONNER NOTE

PLEASE NOTE THAT ALL CONSTRUCTION ACTIVITIES, MATERIALS, PRACTICES AND OTHER REQUIRED ASPECTS OF THE PROJECT MUST BE IN COMPLIANCE WITH THE TOWN OF LA CONNER SPECIFICATIONS, PLANS AND STANDARD DETAILS, WHICH ARE FOUND IN SECTION E OF THE TOWN OF LA CONNER INFRASTRUCTURE IMPROVEMENTS PROJECT MANUAL. THE CONTRACTOR IS REQUIRED TO HAVE A COPY OF THE AFOREMENTIONED MANUAL FOR REFERENCE ON SITE WITH CIVIL PLAN SETS.

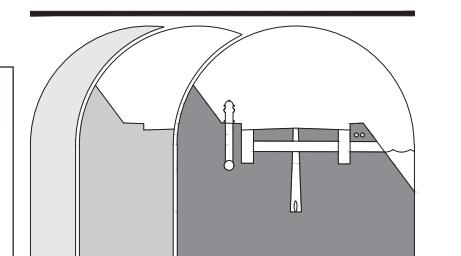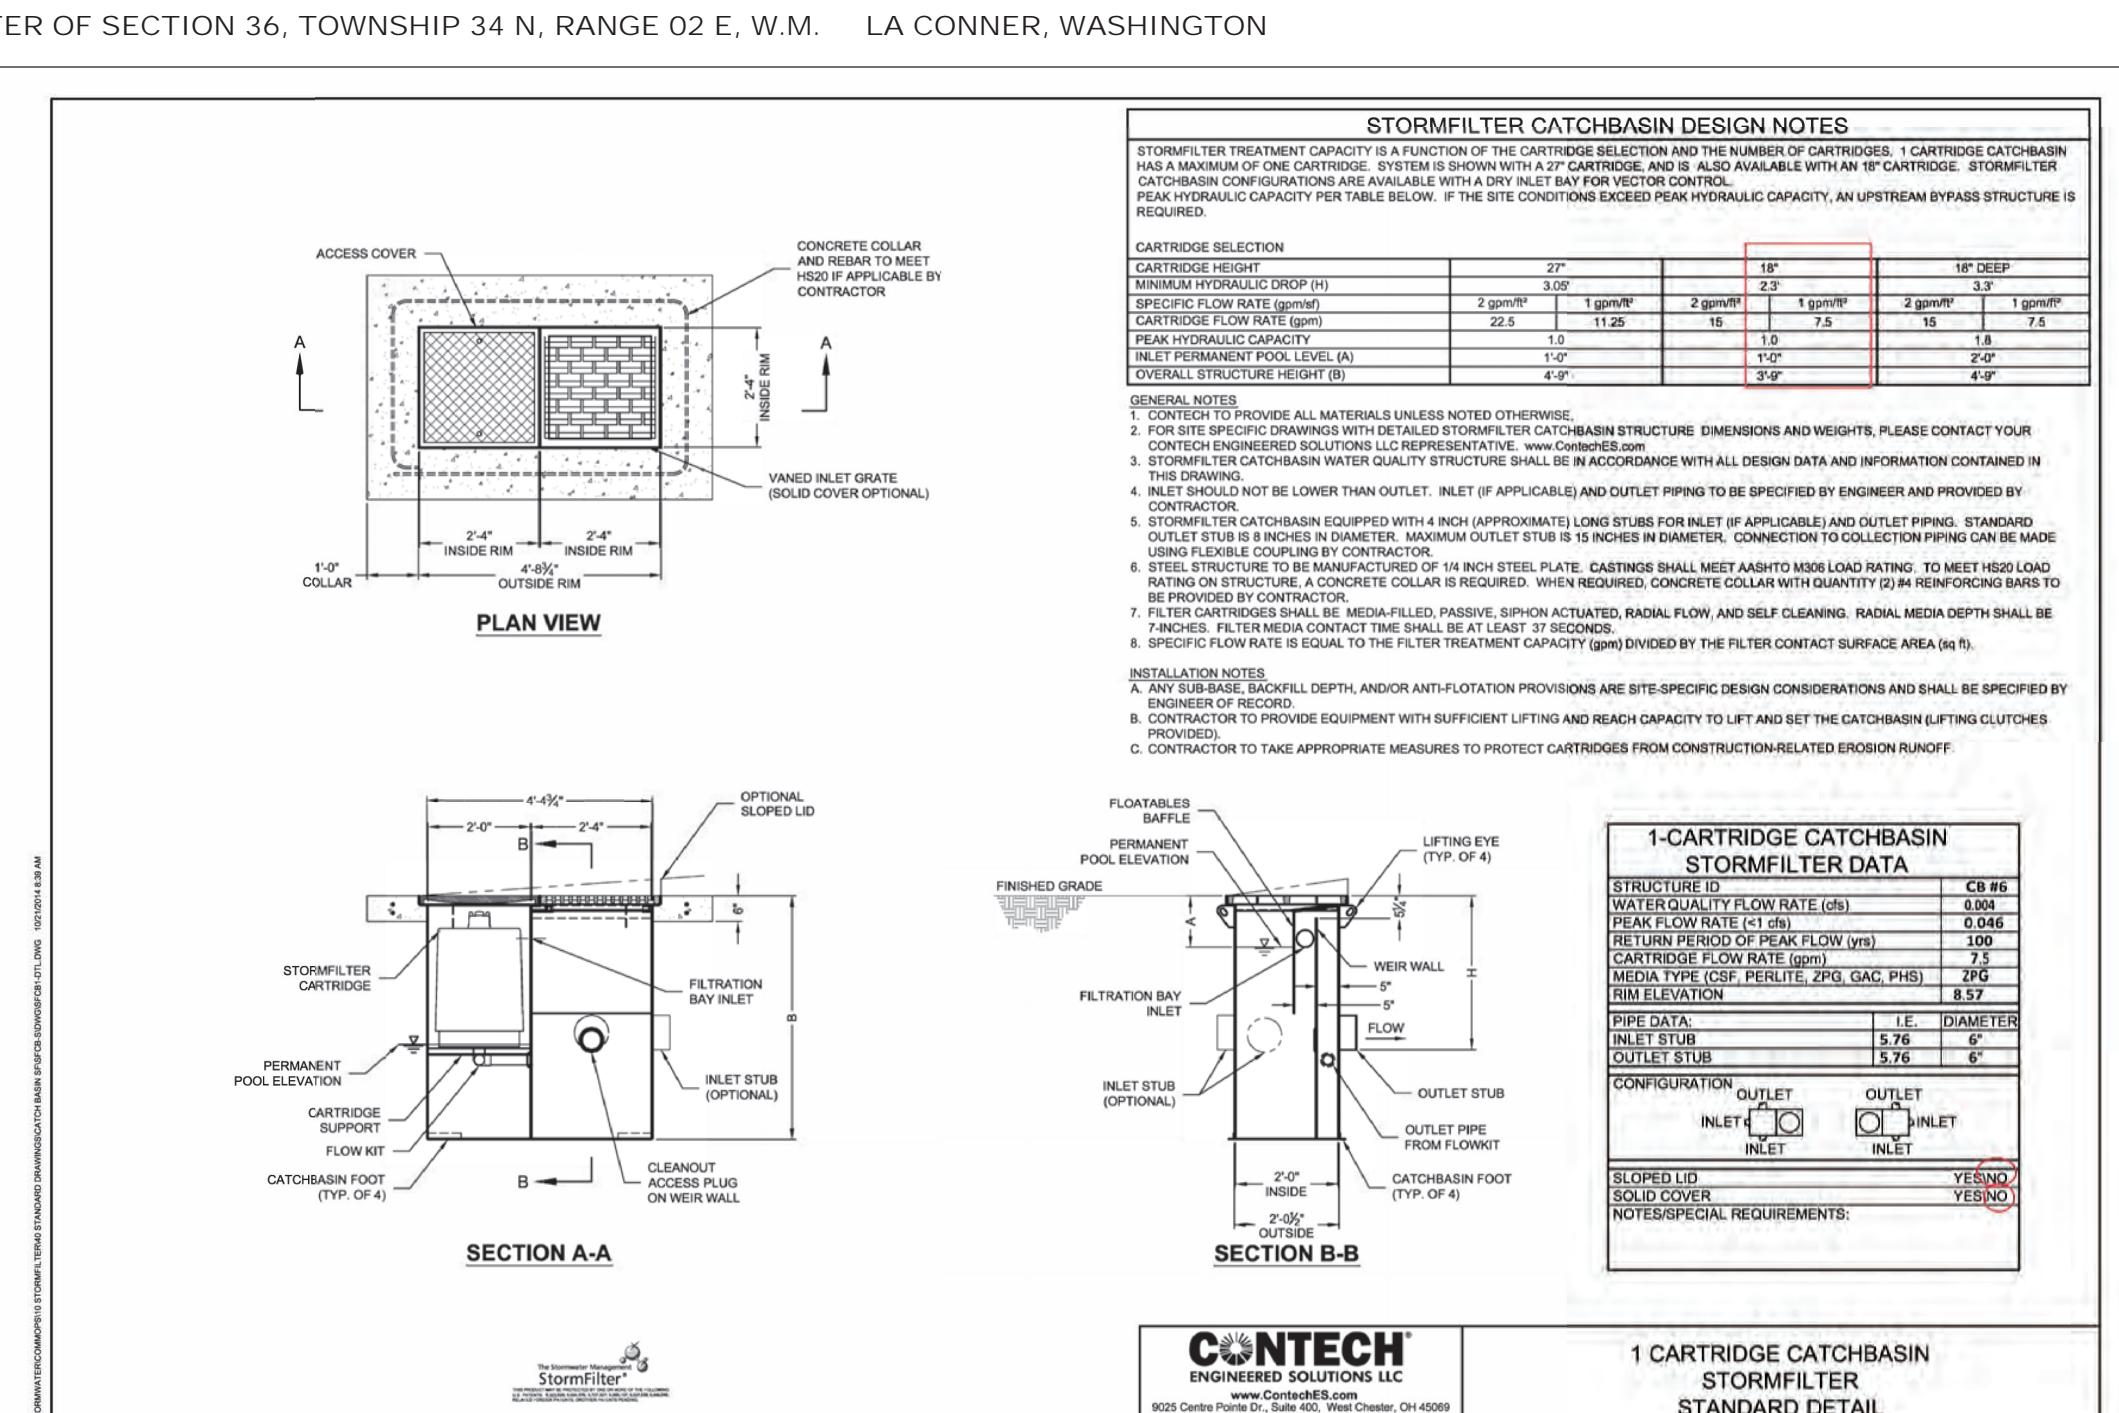

Sound Development Group
ENGINEERING, SURVEYING & LAND DEVELOPMENT SERVICES
P.O. Box 1705 • 1111 Cleveland Avenue, Suite 202
Mount Vernon, WA 98273 Tel: 360-404-2010

SHEET REVISIONS:
NO. DATE DESCRIPTION APPROVED
1 9-22-23 ARCHITECT REVISION P.L.S.

